



# MASSACHUSETTS DEPARTMENT OF TRANSPORTATION HIGHWAY DIVISION

## PLAN OF DRAINAGE REPAIRS AND IMPROVEMENTS AT VARIOUS LOCATIONS (SPY POND)

### IN THE TOWNS OF ARLINGTON & BELMONT MIDDLESEX COUNTY

FEDERAL AID PROJECT NO. (STP)-002S(352)

#### ARLINGTON - BELMONT (SPY POND) DRAINAGE REPAIRS AND IMPROVEMENTS

| STATE            | FED. AID PROJ. NO. | SHEET NO. | TOTAL SHEETS |
|------------------|--------------------|-----------|--------------|
| MASS.            | (STP)-002S(352)    | 01        | 14           |
| PROJECT FILE NO. |                    | 606280    |              |

#### TITLE SHEET & INDEX

THE MASSACHUSETTS HIGHWAY DEPARTMENT STANDARD SPECIFICATIONS FOR HIGHWAYS AND BRIDGES DATED 1988, AS AMENDED, THE SUPPLEMENTAL SPECIFICATIONS DATED JUNE 15, 2012, THE 2012 CONSTRUCTION STANDARD DETAILS, THE 2006 PROJECT DEVELOPMENT AND DESIGN GUIDE, THE 1996 CONSTRUCTION AND TRAFFIC STANDARD DETAILS (AS RELATES TO TRAFFIC STANDARD DETAILS ONLY), THE LATEST MANUAL ON UNIFORM TRAFFIC CONTROL DEVICES FOR STREETS AND HIGHWAYS WITH MASSACHUSETTS AMENDMENTS, THE 1990 STANDARD DRAWINGS FOR SIGNS AND SUPPORTS, THE 1988 STANDARD DRAWINGS FOR TRAFFIC SIGNALS AND HIGHWAY LIGHTING AND THE LATEST EDITION OF THE AMERICAN STANDARD FOR NURSERY STOCK, WILL GOVERN.

#### DESIGN DESIGNATION (STATE ROUTE 2)

|                           |                    |
|---------------------------|--------------------|
| DESIGN SPEED              | 50 MPH             |
| ADT (2009)                | 58,300             |
| FUNCTIONAL CLASSIFICATION | PRINCIPAL ARTERIAL |



#### INDEX

| SHEET NO. | DESCRIPTION                     |
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#### CONVENTIONAL SIGNS

|                                 |                  |
|---------------------------------|------------------|
| COUNTY, CITY, OR TOWN BOUNDARY  | ----             |
| COUNTY, CITY, OR TOWN SIDE LINE | ----             |
| FENCE LINE                      | -X-X-X-X-        |
| BASE LINE OR SURVEY LINE        | S36°04'20"W 2+00 |
| RIGHT OF WAY LINE               | 53.578           |
| CULVERT                         | =====            |
| RETAINING WALL                  | =====            |
| GUARD RAIL                      | T-T-T-T          |
| STONE WALL                      | =====            |
| TREE LINE                       | =====            |
| POLE                            | ○                |

|                  |             |
|------------------|-------------|
| PROPOSED SURFACE | -----       |
| PRESENT SURFACE  | -----       |
| PRES. 90.7       | PROP. 90.91 |
| ELEVATIONS       | 10+20       |

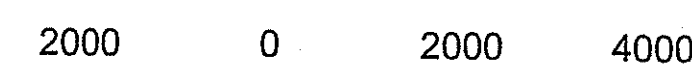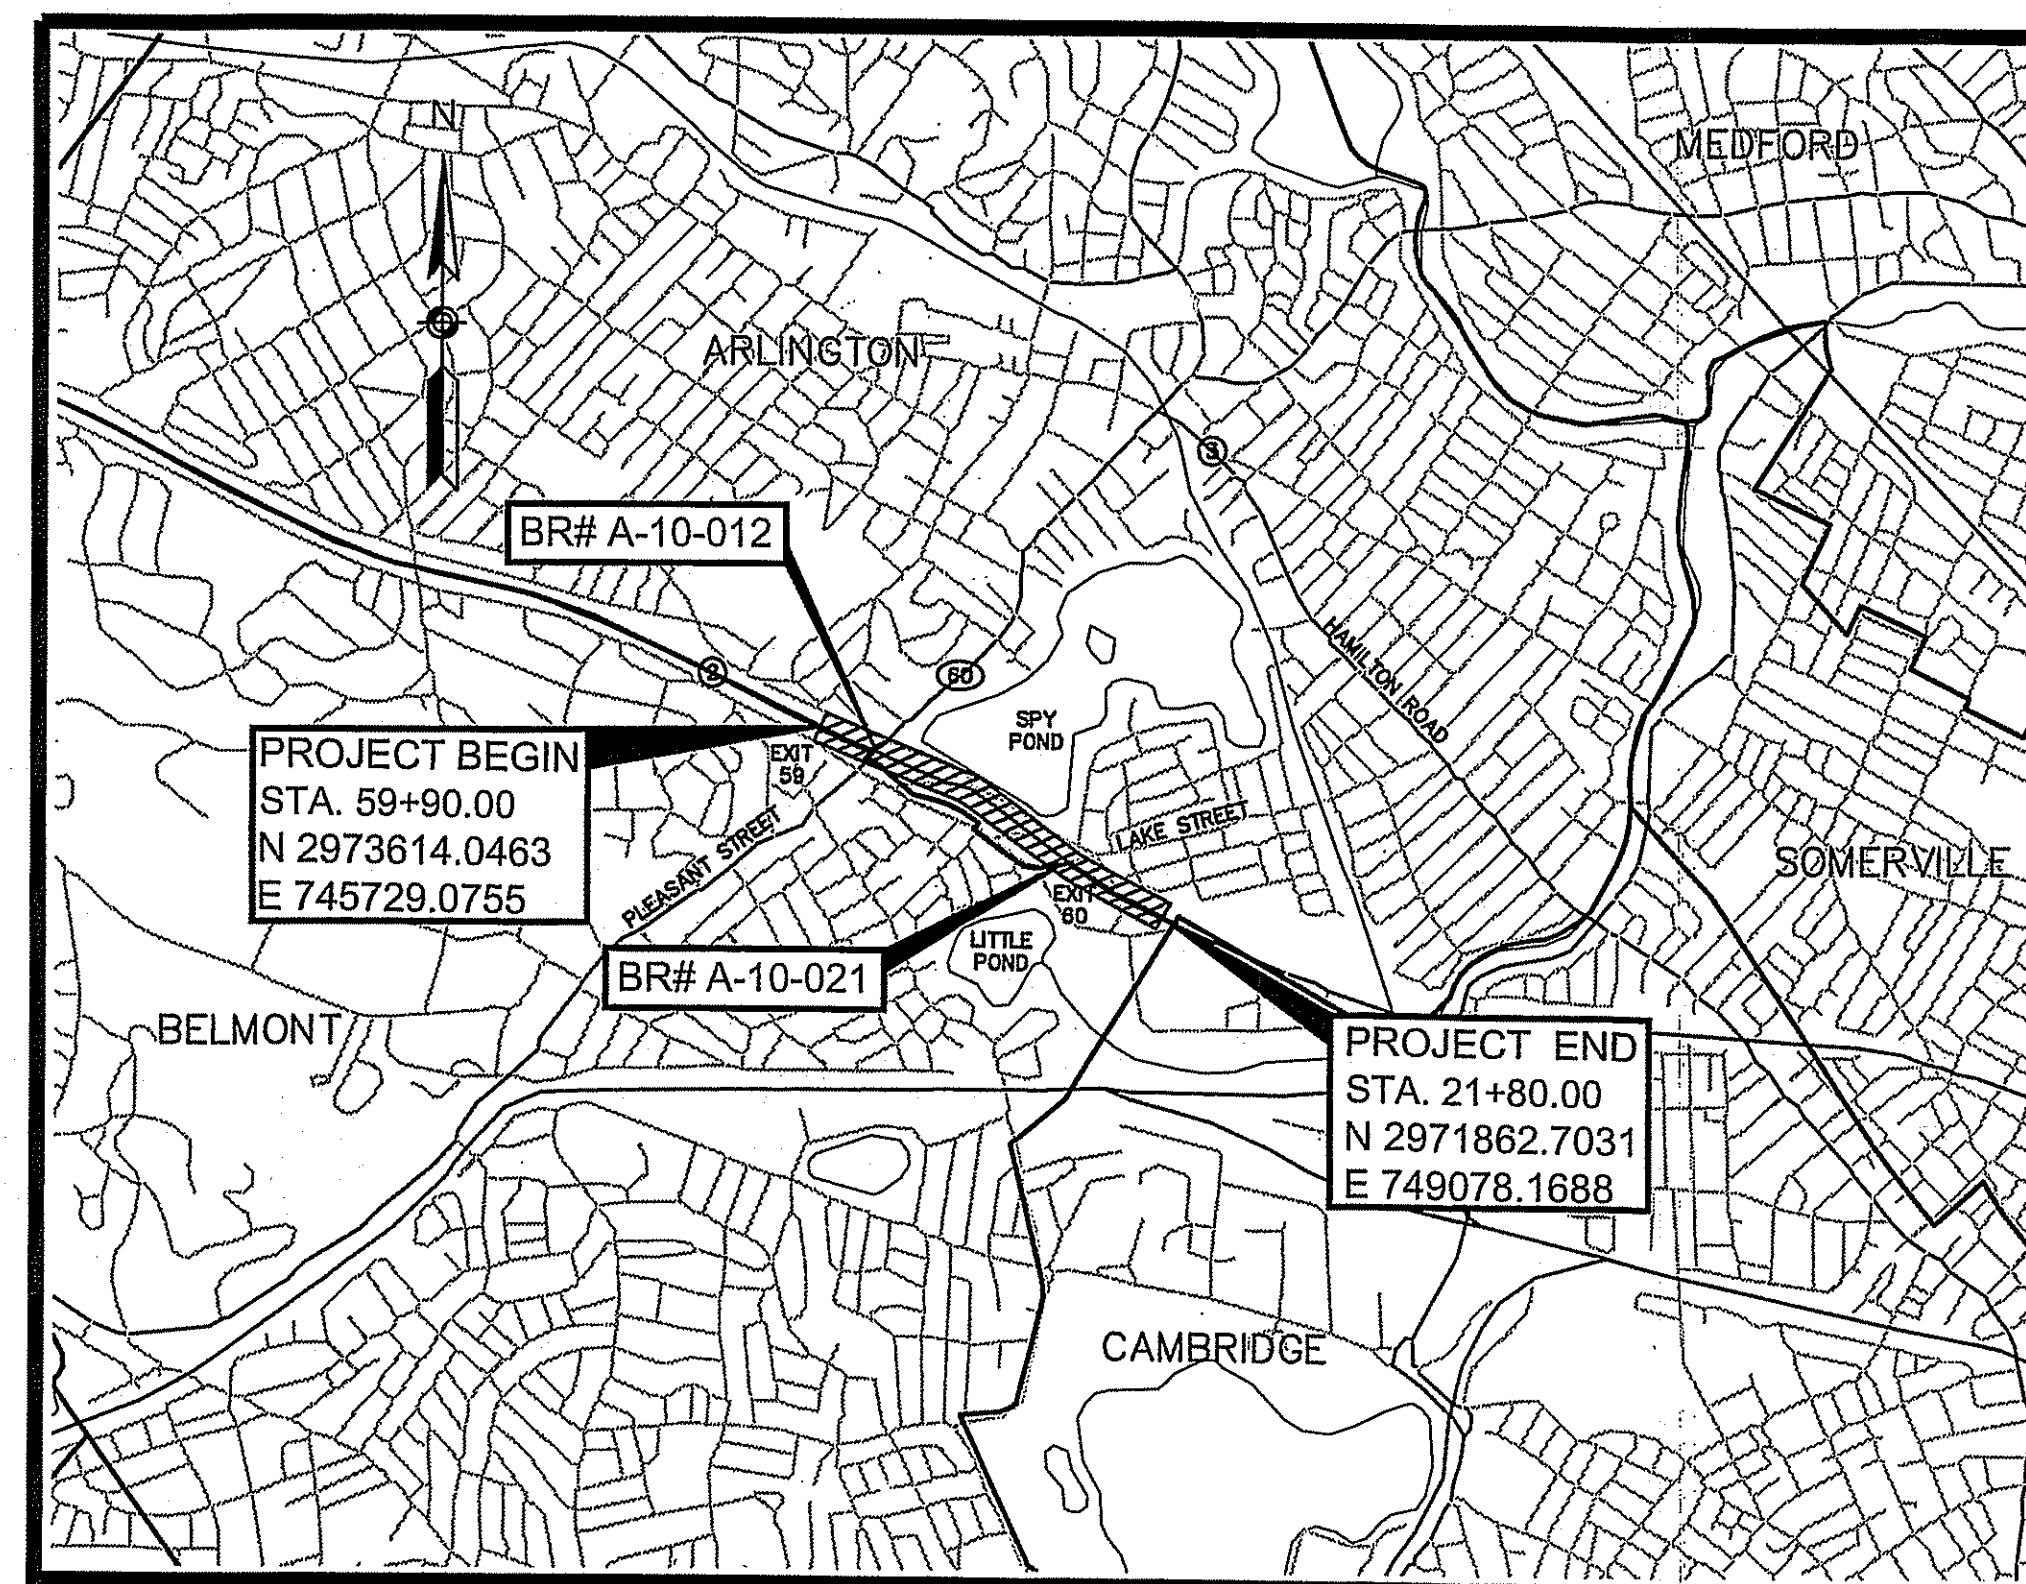

SCALE 1" = 2000'

LENGTH OF PROJECT = 3,810.00 FEET = 0.722 MILES

RDA SUBMISSION



RECOMMENDED FOR APPROVAL

CHIEF ENGINEER DATE

APPROVED

DEPARTMENT OF TRANSPORTATION  
FEDERAL HIGHWAY ADMINISTRATION

APPROVED:

DIVISION ADMINISTRATOR DATE

HIGHWAY ADMINISTRATOR DATE



LEGEND

GENERAL SYMBOLS

EXISTING PROPOSED

|   |                  |  |
|---|------------------|--|
| JB OR BRJB                                | JB OR BRJB       | JERSEY BARRIER ON BRIDGE OR JERSEY BARRIER |
| CB  | CB               | CATCH BASIN                                |
|   | DCB              | DOUBLE CATCH BASIN                         |
| CI  | CI               | CURB INLET                                 |
| BUOY                                      | BUOY             | BUOY                                       |
| FPL                                       | FPL              | FLAG POLE                                  |
|   |                  | GAS PUMP                                   |
|   |                  | FLARED END SECTION                         |
| DI  | DI               | DROP INLET                                 |
| MB  | MB               | MAIL BOX                                   |
| GR  | GRAN POST        | GRANITE POST                               |
| PLN                                       | PLANTER          | PLANTER                                    |
| PST                                       | POST             | POST                                       |
| TBH                                       | TBH              | TELEPHONE BOOTH                            |
| VL  | VL               | VAULT                                      |
| VLV                                       | VLV              | VALVE                                      |
| WELL                                      | WELL             | WELL                                       |
| EH  | EH               | ELECTRIC MANHOLE (HANDHOLE)                |
| FCGA                                      |                  | GATE POST                                  |
| FL  | FL               | FLOW LINE                                  |
|   |                  | GAS GATE                                   |
| BH  | BH               | BORING HOLE                                |
|   |                  | MONITORING WELL                            |
|   | TEP              | TEST PIT                                   |
| HC  | CONC. HDWL       | CONCRETE HEADWALL                          |
| HH  |                  | HANDHOLE                                   |
| HS  | STONE DHWL       | STONE HEADWALL                             |
| HYD                                       | HYD              | HYDRANT                                    |
| LPL                                       | LPL              | LIGHT POLE                                 |
| CO. BO.                                   | CO. BD.          | COUNTY BOUND                               |
| GPS                                       |                  | GPS POINT                                  |
| CMH                                       |                  | CABLE MANHOLE                              |
| DMH                                       |                  | DRAINAGE MANHOLE                           |
| EMH                                       |                  | ELECTRIC MANHOLE                           |
| GMH                                       |                  | GAS MANHOLE                                |
| MMH                                       |                  | MISC MANHOLE                               |
| OMH                                       |                  | OTHER MANHOLE                              |
| SMH                                       |                  | SEWER MANHOLE                              |
| TMH                                       |                  | TELEPHONE MANHOLE                          |
| WMH                                       |                  | WATER MANHOLE                              |
| MHB                                       | MHB              | MHD BOUND                                  |
| MON                                       | MON              | MONUMENT                                   |
| SB  | SB               | STONE BOUND                                |
| TOWN OR CITY BD.                          | TOWN OR CITY BD. | TOWN OR CITY BOUND                         |
| TSN                                       | TSN              | TRAVERSE OR TRIANGULATION STATION          |
| TPL OR GUY                                | TPL OR GUY       | TROLLEY POLE OR GUY POLE                   |
| TRNP                                      |                  | TRANS. POLE                                |
| UFB                                       | UFB              | UP WITH FIREBOX                            |
| LPDL                                      | LPDL             | POLE WITH DOUBLE LIGHT                     |
| ULT                                       | ULT              | UP WITH 1 LIGHT                            |
| UPL                                       | UPL              | UTILITY POLE                               |
| BUSH                                      | BUSH             | BUSH                                       |
| TREE                                      | TREE             | TREE                                       |
| STUMP                                     |                  | STUMP                                      |
| WG  | WG               | SWAMP / MARSH                              |
| FA  | FA               | FIRE ALARM BOX                             |
| PM  | PM               | PARKING METER                              |
|   |                  | ELECTRICAL GROUND                          |
| GV  | GV               | GATE VALVE                                 |
| RIP RAP                                   |                  | RIP RAP                                    |
| OVERHEAD CABLE                            |                  | OVERHEAD CABLE                             |
| DIRECT BURIAL CABLE                       |                  | DIRECT BURIAL CABLE                        |
| CURBING                                   |                  | CURBING                                    |
| CONTOURS                                  |                  | CONTOURS                                   |
| DRAIN PIPE (DOUBLE LINE 24 INCH AND OVER) |                  | DRAIN PIPE (DOUBLE LINE 24 INCH AND OVER)  |
| ELECTRIC DUCT                             |                  | ELECTRIC DUCT                              |
| GAS MAIN                                  |                  | GAS MAIN                                   |
| SEWER MAIN                                |                  | SEWER MAIN                                 |
| TELEPHONE DUCT                            |                  | TELEPHONE DUCT                             |
| WATER MAIN                                |                  | WATER MAIN                                 |
| BALANCE STONE WALL                        |                  | BALANCE STONE WALL                         |
| CULVERT                                   |                  | CULVERT                                    |
| GUARD RAIL                                |                  | GUARD RAIL                                 |
| GUTTER LINE AT DRIVEWAYS                  |                  | GUTTER LINE AT DRIVEWAYS                   |
| CHAIN LINK FENCE                          |                  | CHAIN LINK FENCE                           |
| STOCKADE FENCE                            |                  | STOCKADE FENCE                             |

GENERAL SYMBOLS (CONT.)

EXISTING PROPOSED

|                |                |  |
|----------------|----------------|--|
|                |                | HAY BALES/SILT FENCE                             |
|                |                | LINEAR EROSION CONTROL                           |
|                |                | RETAINING WALL                                   |
|                |                | TREE LINE OR LIMIT OF CLEARING AND GRUBBING      |
|                |                | SAWCUT LINE                                      |
|                |                | TOP OR BOTTOM OF SLOPE                           |
|                |                | LIMIT OF EDGE OF PAVEMENT OR COLD PLAN & OVERLAY |
|                |                | BANK OF RIVER OR STREAM                          |
|                |                | BORDER OF WETLAND                                |
| 100' BZ        | 100' BZ        | 100 FT WETLAND BUFFER ZONE                       |
| 200' RA        | 200' RA        | 200 FT RIVERFRONT AREA                           |
| DATE OF LAYOUT | DATE OF LAYOUT | STATE HIGHWAY LAYOUT                             |
| DATE OF LAYOUT | DATE OF LAYOUT | TOWN OR CITY LAYOUT                              |
| DATE OF LAYOUT | DATE OF LAYOUT | COUNTY LAYOUT                                    |
| R.R. S/L       |                | RAILROAD SIDELINE                                |
|                |                | TOWN OR CITY BOUNDARY LINE                       |
| OR APPROX. P.  |                | PROPERTY LINE OR APPROXIMATE PROPERTY LINE       |
|                |                | EASEMENT   |

TRAFFIC SIGNAL SYMBOLS

EXISTING PROPOSED

|      |      |  |
|------|------|--|
| 1    | 1    | CONTROLLER PHASE ACTUATED  |
|      |      | TRAFFIC SIGNAL HEAD (SIZE AS NOTED)                                  |
|      |      | WIRE LOOP DETECTOR (6'X 6' TYPICAL UNLESS OTHERWISE SPECIFIED)       |
|      |      | VIDEO SURVEILLANCE CAMERA  |
|      |      | MICROWAVE DETECTOR   |
|      |      | MAGNETOMETER (2 SHOWN)   |
|      |      | PEDESTRIAN PUSH BUTTON, SIGN (DIRECTIONAL ARROW AS SHOWN) AND SADDLE |
| *    | *    | OPTICOM CONFIRMATION STROBE LIGHT                                    |
|      |      | VEHICULAR SIGNAL HEAD  |
|      |      | VEHICULAR SIGNAL HEAD, OPTICALLY PROGRAMMED                          |
|      |      | FLASHING BEACON  |
|      |      | PEDESTRIAN SIGNAL HEAD (TYPE AS NOTED OR AS SPECIFIED)               |
|      |      | PEDESTRIAN SIGNAL HEAD, OPTICALLY PROGRAMMED                         |
|      |      | PEDESTRIAN SIGNAL POST AND BASE                                      |
| RRSG | RRSG | RAILROAD SIGNAL  |
|      |      | SIGNAL POST AND BASE (ALPHA-NUMERIC DESIGNATION NOTED)               |
| 20'  | 20'  | STEEL OR ALUMINUM MAST ARM, SHAFT AND BASE (ARM LENGTH AS NOTED)     |
|      |      | HIGH MAST POLE OR TOWER  |
|      |      | SIGN AND POST  |
|      |      | SIGN AND POST (TWO POSTS)  |
| 20'  | 20'  | SIGNAL AND LIGHTING MAST ARM (OPTICOM)                               |
|      |      | EMERGENCY PRE-EMPTION DETECTOR                                       |
|      |      | CONTROL CABINET, GROUND MOUNTED                                      |
|      |      | CONTROL CABINET, POLE MOUNTED  |
|      |      | FLASHING BEACON CONTROL & METER PEDESTAL                             |
|      |      | LOAD CENTER ASSEMBLY   |
|      |      | PULL BOX 12"X12" (AND AS NOTED)                                      |
|      |      | ELECTRIC HANDHOLE 12" X 24"  |
| ==   | ==   | TRAFFIC SIGNAL INTERCONNECT CONDUIT                                  |
| ==   | ==   | TRAFFIC SIGNAL CONDUIT (TYPE AS NOTED)                               |

PAVEMENT MARKINGS AND SIGNING SYSBOLS

EXISTING PROPOSED

|       |       |   |
|-------|-------|---|
| ONLY  | ONLY  | PAVEMENT ARROW - WHITE                                    |
|       |       | LEGEND "ONLY" - WHITE                                     |
|       |       | STOP LINE - 12"   |
|       |       | CROSSWALK   |
| SWLL  | SWLL  | SOLID WHITE LANE LINE                                     |
| BWLL  | BWLL  | BROKEN WHITE LANE LINE (10' LINE, 30' SPACE TYP.)         |
| SWEL  | SWEL  | SOLID WHITE EDGE LINE                                     |
| YGL   | YGL   | YELLOW GORE LINE - 12"                                    |
| DYCL  | DYCL  | DOUBLE YELLOW CENTER LINE                                 |
| SWCHL | SWCHL | SOLID WHITE CHANNELIZATION LINE - 8"                      |
| WGL   | WGL   | WHITE GORE LINE - 12"                                     |
| SYEL  | SYEL  | SOLID YELLOW EDGE LINE                                    |
| BYCL  | BYCL  | BROKEN YELLOW CENTER LINE (10' LINE, 30' SPACE TYP.) - 4" |
| SYCL  | SYCL  | SOLID YELLOW CENTER LINE                                  |
| DWLL  | DWLL  | DOTTED WHITE LANE LINE - 4" (2' LINE, 4' SPACE)           |
|       |       | DIRECTION OF TRAFFIC FLOW                                 |

ARLINGTON - BELMONT (SPY POND)  
DRAINAGE REPAIRS AND IMPROVEMENTS

|                  |                    |           |              |
|------------------|--------------------|-----------|--------------|
| STATE            | FED. AID PROJ. NO. | SHEET NO. | TOTAL SHEETS |
| MA               | (STP)-002S(352)    | 02        | 14           |
| PROJECT FILE NO. |                    | 606280    |              |

LEGEND & GENERAL NOTES

GENERAL NOTES

- TOPOGRAPHICAL INFORMATION FROM A SURVEY BY VANASSE HANGEN BRUSTLIN, INC., WATERTOWN, MASSACHUSETTS IN MAY, 2012 (HORIZONTAL DATUM: NAD83, VERTICAL DATUM: NAVD88).
- THE LOCATIONS OF EXISTING UNDERGROUND UTILITIES ARE SHOWN IN AN APPROXIMATE WAY ONLY AND HAVE NOT BEEN INDEPENDENTLY VERIFIED BY THE OWNER OR ITS REPRESENTATIVE. THE CONTRACTOR SHALL DETERMINE THE EXACT LOCATION OF ALL EXISTING UTILITIES BEFORE COMMENCING WORK, AND SHALL BE FULLY RESPONSIBLE FOR ANY AND ALL DAMAGES WHICH MIGHT BE OCCASIONED BY THE CONTRACTOR'S FAILURE TO EXACTLY LOCATE AND PRESERVE ANY AND ALL UNDERGROUND UTILITIES. CONTRACTOR SHALL NOTIFY "DIG-SAFE" (1-888-344-7233) AT LEAST 72 HOURS BEFORE EXCAVATING.
- WHERE AN EXISTING UTILITY IS FOUND TO CONFLICT WITH THE PROPOSED WORK, THE LOCATION, ELEVATION AND SIZE OF THE UTILITY SHALL BE ACCURATELY DETERMINED WITHOUT DELAY BY THE CONTRACTOR, AND THE INFORMATION FURNISHED TO THE ENGINEER FOR RESOLUTION OF THE CONFLICT.
- THE CONTRACTOR SHALL ALTER THE MASONRY OF THE TOP SECTION OF ALL EXISTING DRAINAGE STRUCTURES AS NECESSARY FOR CHANGES IN GRADE, AND RESET ALL WATER AND DRAINAGE FRAMES, GRATES AND BOXES TO THE PROPOSED FINISH SURFACE GRADE. REQUIRED NEW MASONRY SHALL BE CLAY BRICK CONFORMING TO M4.05.2.
- THE CONTRACTOR SHALL MAKE ALL ARRANGEMENTS FOR THE ALTERATION AND ADJUSTMENT OF GAS, ELECTRIC, TELEPHONE AND ANY OTHER PRIVATE UTILITIES BY THE UTILITY COMPANIES.
- TREES AND SHRUBS WITHIN THE LIMITS OF GRADING SHALL BE REMOVED ONLY UPON APPROVAL OF THE ENGINEER.
- AREAS OUTSIDE THE LIMITS OF PROPOSED WORK DISTURBED BY THE CONTRACTOR'S OPERATIONS SHALL BE RESTORED BY THE CONTRACTOR TO THEIR ORIGINAL CONDITION AT NO EXPENSE TO THE OWNER.
- THE TERM "PROPOSED" (PROP) MEANS WORK TO BE CONSTRUCTED USING NEW MATERIALS OR, WHERE APPLICABLE, RE-USING EXISTING MATERIALS IDENTIFIED AS "REMOVE AND RESET" (R&R).
- ALL LATERAL DRAIN PIPES SHALL BE INSTALLED WITH A PITCH OF .01 FOOT PER FOOT (MINIMUM) UNLESS NOTED OTHERWISE ON THE DRAWINGS.
- ALL EXISTING STATE, COUNTY, CITY, AND TOWN LOCATION LINES AND PRIVATE PROPERTY LINES HAVE BEEN ESTABLISHED FROM AVAILABLE INFORMATION AND THEIR EXACT LOCATION ARE NOT GUARANTEED.
- THIS PROJECT DISTURBS MORE THAN ONE ACRE OF LAND AND FALLS WITHIN THE NPDES CONSTRUCTION GENERAL PERMIT (CGP) PROGRAM AND EPA JURISDICTION. PRIOR TO THE START OF CONSTRUCTION CONTRACTOR IS TO FILE A CGP NOTICE OF INTENT WITH THE EPA AND PREPARE A STORMWATER POLLUTION PREVENTION PLAN IN ACCORDANCE WITH THE NPDES REGULATIONS. CONTRACTOR SHALL CONFIRM THE OWNER HAS ALSO FILED A NOTICE OF INTENT WITH THE EPA.
- WETLAND BOUNDARIES ARE BASED ON THE MASSGIS WETLANDS DATA LAYER AND REVIEWED IN THE FIELD BY A VHB ENVIRONMENTAL SCIENTIST. THE BOUNDARIES WERE REVISED AS NEEDED ON THE PLANS TO REFLECT EXISTING CONDITIONS IN THE FIELD. THE JURISDICTIONAL STATUS OF THE WETLAND RESOURCE AREAS WAS DETERMINED DURING THE FIELD INVESTIGATION.

ABBREVIATIONS

GENERAL


|               |                                     |         |                             |          |                                |
|---------------|-------------------------------------|---------|-----------------------------|----------|--------------------------------|
| AADT          | ANNUAL AVERAGE DAILY TRAFFIC        | EXC     | EXCAVATION                  | PVC      | POINT OF VERTICAL CURVE        |
| ABAN          | ABANDON                             | F&C     | FRAME AND COVER             | PVI      | POINT OF VERTICAL INTERSECTION |
| ADJ           | ADJUST                              | F&G     | FRAME AND GRATE             | PVT      | POINT OF VERTICAL TANGENCY     |
| APPROX.       | APPROXIMATE                         | FDN.    | FOUNDATION                  | PVMT     | PAVEMENT                       |
| A.C.          | ASPHALT CONCRETE                    | FES     | FLARED END SECTION          | PWW      | PAVED WATER WAY                |
| ACCM PIPE     | ASPHALT COATED CORRUGATED           | FLDSTN  | FIELDSTONE                  | R        | RADIUS OF CURVATURE            |
|               | METAL PIPE                          | GAR     | GARAGE                      | R&D      | REMOVE AND DISPOSE             |
| BIT.          | BITUMINOUS                          | GD      | GROUND                      | RCP      | REINFORCED CONCRETE PIPE       |
| BC            | BOTTOM OF CURB                      | GG      | GAS GATE                    | RD       | ROAD                           |
| BD.           | BOUND                               | GI      | GUTTER INLET                | RDWY     | ROADWAY                        |
| BL            | BASELINE                            | GIP     | GALVANIZED IRON PIPE        | REM      | REMOVE                         |
| BLDG          | BUILDING                            | GRAN    | GRANITE                     | RET      | RETAIN                         |
| BM            | BENCH MARK                          | GRAV    | GRAVEL                      | RET WALL | RETAINING WALL                 |
| BO            | BY OTHERS                           | GRD     | GUARD                       | ROW      | RIGHT-OF-WAY                   |
| BOS           | BOTTOM OF SLOPE                     | GTD     | GRADE TO DRAIN              | RR       | RAILROAD                       |
| BR.           | BRIDGE                              | HH      | HAND HOLE                   | R&D      | REMOVE AND DISCARD             |
| CB            | CATCH BASIN                         | HDW, HW | HEADWALL                    | R&R      | REMOVE AND RESET               |
| CBCL          | CATCH BASIN WITH CURB INLET         | HMA     | HOT MIX ASPHALT             | R&S      | REMOVE AND STACK               |
| CC            | CEMENT CONCRETE                     | HOR     | HORIZONTAL                  | RT       | RIGHT                          |
| CCM           | CEMENT CONCRETE MASONRY             | HYD     | HYDRANT                     | SB       | STONE BOUND                    |
| CEM           | CEMENT                              | INV     | INVERT                      | SHLD     | SHOULDER                       |
| CI            | CURB INLET                          | JCT     | JUNCTION                    | SMH      | SEWER MANHOLE                  |
| CIP           | CAST IRON PIPE                      | L       | LENGTH OF CURVE             | ST       | STREET                         |
| CLF           | CHAIN LINK FENCE                    | LB      | LEACHING BASIN              | STA      | STATION                        |
| CL            | CENTERLINE                          | LP      | LIGHT POLE                  | SSD      | STOPPING SIGHT DISTANCE        |
| CMP           | CORRUGATED METAL PIPE               | LT      | LEFT                        | SHLO     | STATE HIGHWAY LAYOUT LINE      |
| CSP           | CORRUGATED STEEL PIPE               | MAX     | MAXIMUM                     | SW       | SIDEWALK                       |
| CO.           | COUNTY                              | MB      | MAIL BOX                    | T        | TANGENT DISTANCE OF CURVE/     |
| CONC          | CONCRETE                            | MH      | MANHOLE                     |          | TRUCK PERCENTAGE               |
| CONT          | CONTINUOUS                          | MHB     | MASSACHUSETTS HIGHWAY BOUND | TAN      | TANGENT                        |
| CONST         | CONSTRUCTION                        | MIN     | MINIMUM                     | TEMP     | TEMPORARY                      |
| CR GR         | CROWN GRADE                         | NIC     | NOT IN CONTRACT             | TC       | TOP OF CURB                    |
| DHV           | DESIGN HOURLY VOLUME                | NO.     | NUMBER                      | TOS      | TOP OF SLOPE                   |
| DI            | DROP INLET                          | PC      | POINT OF CURVATURE          | TYP      | TYPICAL                        |
| DIA           | DIAMETER                            | PCC     | POINT OF COMPOUND CURVATURE | UP       | UTILITY POLE                   |
| DIP           | DUCTILE IRON PIPE                   | P.G.L.  | PROFILE GRADE LINE          | VAR      | VARIES                         |
| DW            | STEADY DON'T WALK - PORTLAND ORANGE | PI      | POINT OF INTERSECTION       | VERT     | VERTICAL                       |
| DWY           | DRIVEWAY                            | POC     | POINT ON CURVE              | VC       | VERTICAL CURVE                 |
| ELEV (OR EL.) | ELEVATION                           | POT     | POINT ON TANGENT            | WCR      | WHEELCHAIR RAMP                |
| EMB           | EMBANKMENT                          | PRC     | POINT OF REVERSE CURVATURE  | WG       | WATER GATE                     |
| EOP           | EDGE OF PAVEMENT                    | PROJ    | PROJECT                     | WIP      | WROUGHT IRON PIPE              |
| EXIST (OR EX) | EXISTING                            | PROP    | PROPOSED                    | WM       | WATER METER/WATER MAIN         |
|               |                                     | PSB     | PLANTABLE SOIL BORROW       | X-SECT   | CROSS SECTION                  |
|               |                                     | PT      | POINT OF TANGENCY           |          |                                |

| CONCORD TURNPIKE (RT. 2) CONSTRUCTION BASELINE DATA |                  |             |  |                        |              |             |
|---|------------------|-------------|--|------------------------|--------------|-------------|
| NUMBER  | STARTING STATION | END STATION | CURVE DATA                                 | LINE DATA              | NORTHING     | EASTING     |
| C17   | 10+05.57         | 18+46.06    | R=4600.00' Δ=10°28'08" L=840.49' T=421.42' |                        | 2971279.4214 | 750095.0203 |
| L18   | 18+46.06         | 22+00.00    |  | N56° 24' 56"W 353.94'  | 2971677.9790 | 749356.3647 |
| C14   | 22+00.00         | 26+35.39    | R=4600.00' Δ=5°25'23" L=435.39' T=217.86'  |                        | 2971873.7664 | 749061.5074 |
| L15   | 26+35.39         | 32+14.32    |  | N50° 59' 04"W 578.93'  | 2972131.4519 | 748710.7627 |
| C15   | 32+14.32         | 37+28.94    | R=1600.00' Δ=18°25'43" L=614.62' T=259.55' |                        | 2972495.9065 | 748260.9485 |
| L16   | 37+28.94         | 50+44.10    |  | N69° 24' 47"W 1315.16' | 2972750.5698 | 747816.3036 |
| C16   | 50+44.10         | 55+32.71    | R=4600.00' Δ=6°05'09" L=488.60' T=244.53'  |                        | 2973213.0173 | 746585.1301 |
| L17   | 55+32.71         | 67+38.34    |  | N63° 19' 38"W 1205.63' | 2973408.7699 | 746137.7058 |

ARLINGTON - BELMONT (SPY POND) DARK BROOK  
DRAINAGE REPAIRS AND IMPROVEMENTS

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KEY AND BASELINE DATA PLAN



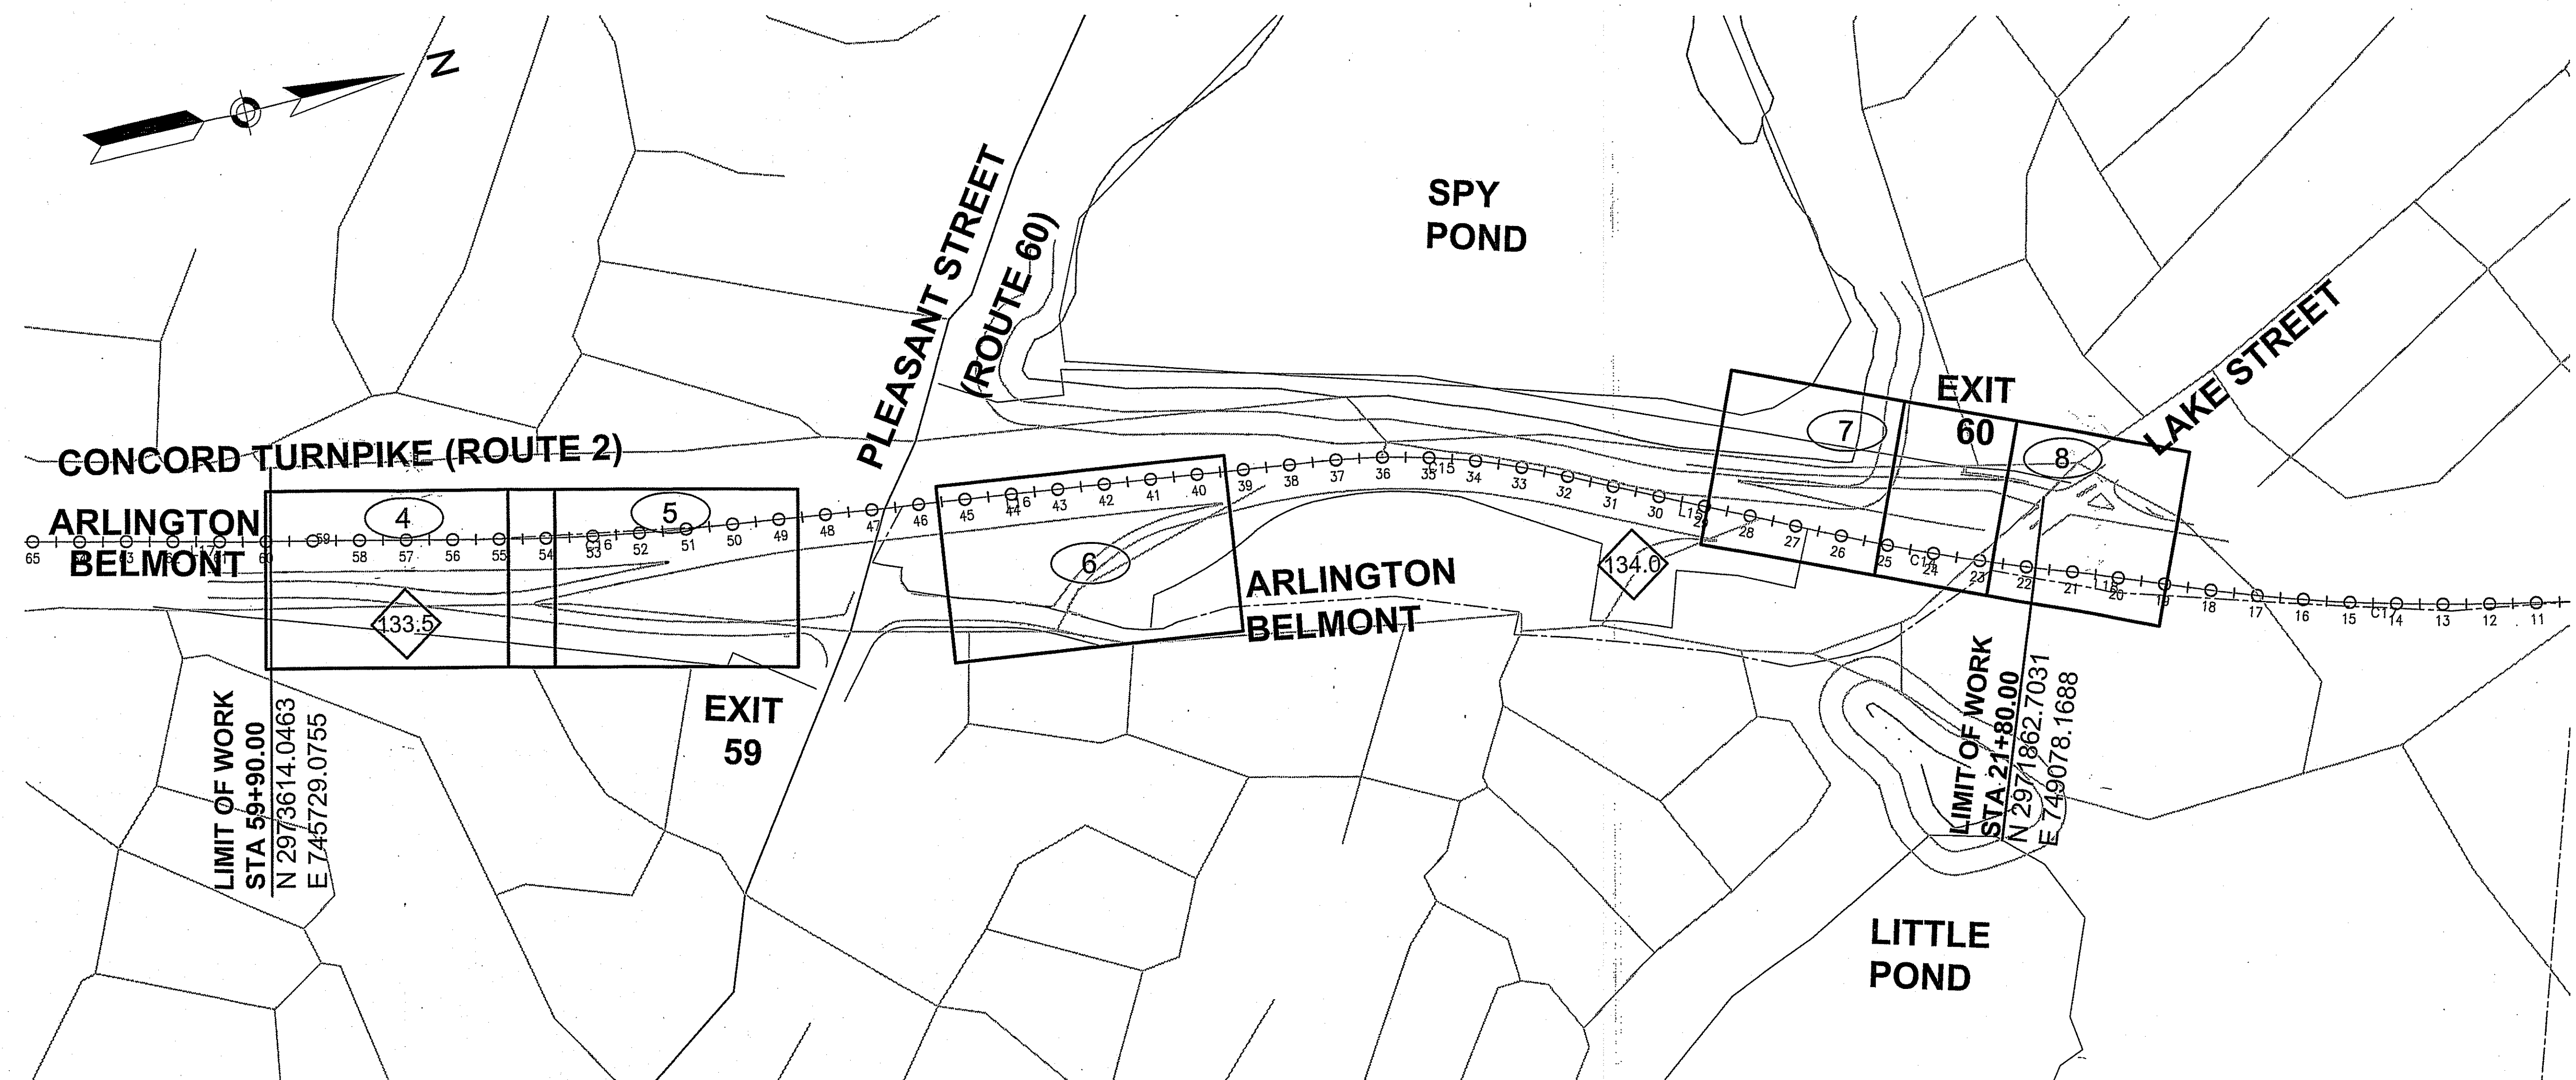


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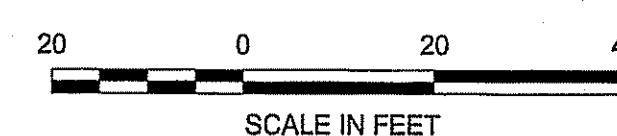
## CONSTRUCTION PLANS

| CONCORD TURNPIKE (RT. 2) CHECK DAM DATA |           |                   |               |         |
|---|-----------|-------------------|---------------|---------|
| NO.                                     | TYPE      | STATION           | TOP ELEVATION | REMARKS |
| 1A                                      | CHECK DAM | 56+74.8<br>84.8 L | 74.0          |         |
| 1B                                      | CHECK DAM | 55+90.0<br>86.1 L | 70.0          |         |
| 1C                                      | CHECK DAM | 55+28.6<br>89.4 L | 67.0          |         |
| 1D                                      | CHECK DAM | 54+82.9<br>90.9 L | 64.0          |         |
| 1E                                      | CHECK DAM | 54+21.2<br>87.4 L | 61.5          |         |



| CONCORD TURNPIKE (RT. 2) DRAINAGE STRUCTURE DATA |       |                    |           |                      |          |  |
|--|-------|--------------------|-----------|----------------------|----------|--|
| NO.  | TYPE  | STATION            | RIM ELEV. | INV. IN              | INV. OUT | REMARKS                                |
| 1  | DMH   | 59+49.3<br>76.0 L  | 88.3      | (3) 83.3<br>(2) 83.8 | 83.2     |  |
| 2  | EX CB | 59+60.3<br>66.3 L  | 87.9      |                      | 83.9     | R&D EXIST F&G PROP F&G                 |
| 3  | EX CB | 59+71.8<br>120.1 L | 88.2      |                      | 83.7     | R&D EXIST F&G PROP F&G                 |
| 4  | FES   | 57+36.8<br>83.8 L  | —         | (1) 76.5             |          | LENGTH OF STONE FOR<br>PIPE ENDS = 18' |
| 5  | EX CB | 57+24.8<br>133.9 L | 75.9      |                      | 71.5     | R&D EXIST F&G PROP F&G                 |
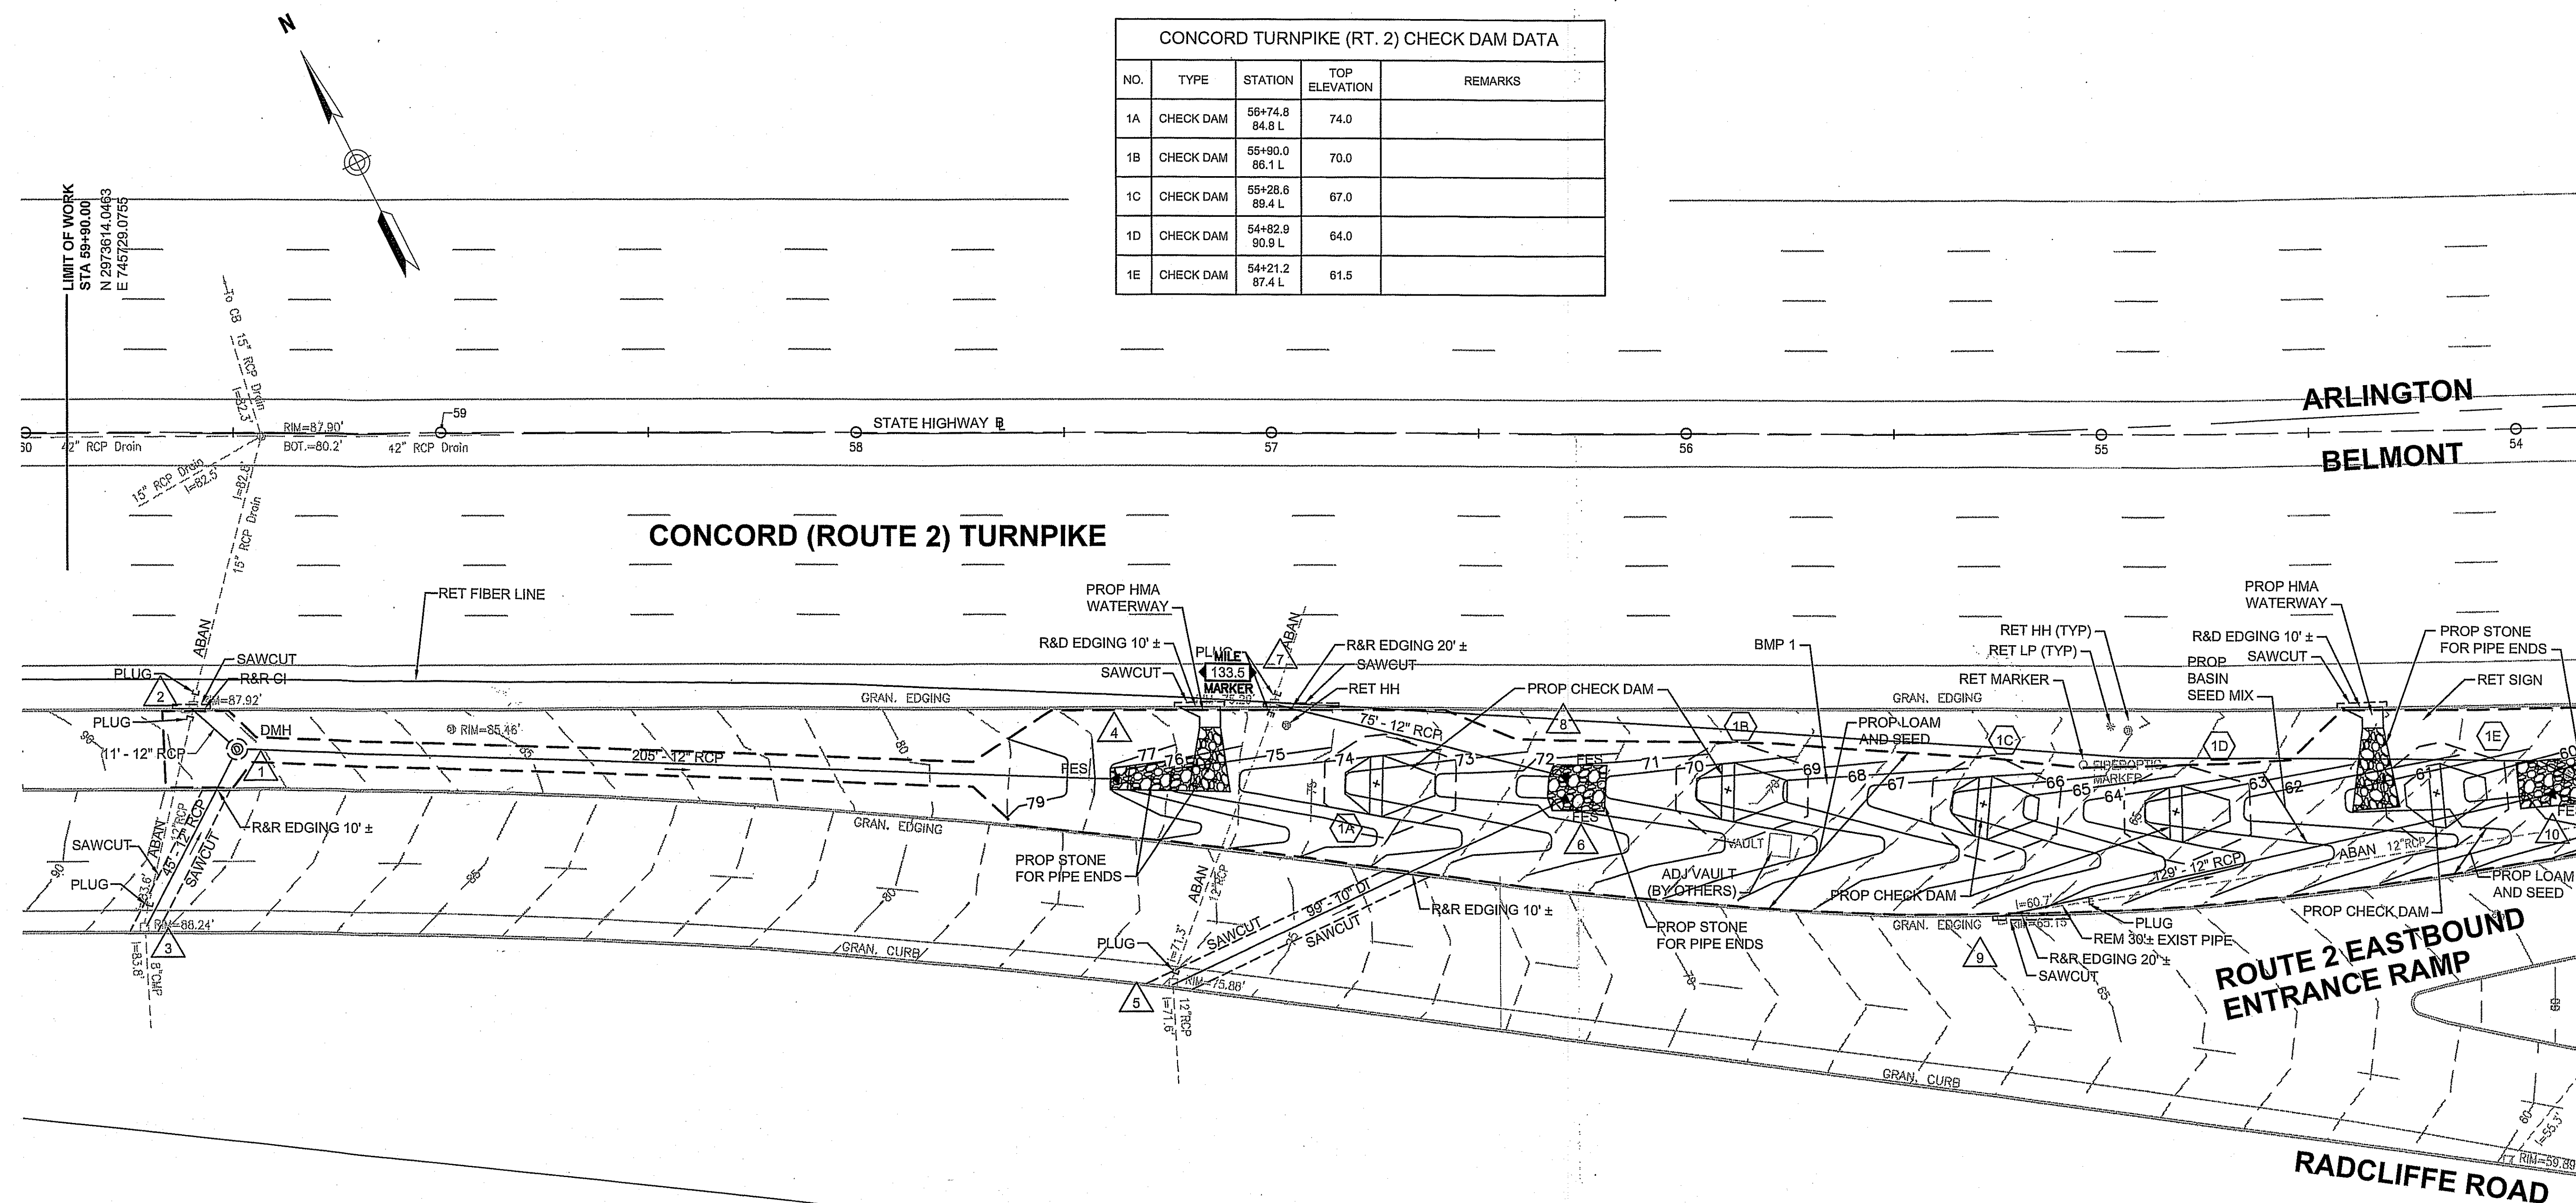
| CONCORD TURNPIKE (RT. 2) DRAINAGE STRUCTURE DATA |       |                    |           |          |          |  |
|--|-------|--------------------|-----------|----------|----------|--|
| NO.  | TYPE  | STATION            | RIM ELEV. | INV. IN  | INV. OUT | REMARKS                                |
| 6  | FES   | 56+28.7<br>83.0 L  | --        | (5) 70.5 |          | LENGTH OF STONE FOR<br>PIPE ENDS = 10' |
| 7  | EX CB | 56+99.5<br>66.3 L  | 75.3      |          | 71.3     | R&D EXIST F&G PROP F&G                 |
| 8  | FES   | 56+28.6<br>83.0 L  | --        | (7) 70.5 |          | LENGTH OF STONE FOR<br>PIPE ENDS = 10' |
| 9  | EX CB | 55+24.3<br>116.3 L | 65.2      |          | 60.7     | R&D EXIST F&G PROP F&G                 |
| 10   | FES   | 53+93.3<br>88.0 L  | --        | (9) 59.0 |          | LENGTH OF STONE FOR<br>PIPE ENDS = 10' |



CONTINUED ON

# HIGHWAY GUARD DETAILS

NONE

# DRAINAGE DETAILS


SEE BELOW

# ARLINGTON - BELMONT (SPY POND) DRAINAGE REPAIRS AND IMPROVEMENTS

| STATE            | FED. AID PROJ. NO. | SHEET NO. | TOTAL SHEETS |
|------------------|--------------------|-----------|--------------|
| MA               | (STP)-002S(352)    | 05        | 14           |
| PROJECT FILE NO. |                    | 606280    |              |

# CONSTRUCTION PLANS

| CONCORD TURNPIKE (RT. 2) DRAINAGE STRUCTURE DATA |        |                    |           |           |          |                        |
|--|--------|--------------------|-----------|-----------|----------|------------------------|
| NO.  | TYPE   | STATION            | RIM ELEV. | INV. IN   | INV. OUT | REMARKS                |
| 11   | DI     | 53+53.2<br>81.2 L  | 58.1      |           | 54.5     | TYPE A                 |
| 12   | DMH    | 53+17.7<br>77.6 L  | 56.6      |           |          | BUILD OVER EXIST DRAIN |
| 13   | EX DMH | 53+33.5<br>69.2 L  | 56.5      |           | 49.9     |                        |
| 14   | EX CB  | 53+32.1<br>66.5 L  | 57.7      |           | 53.7     | R&D EXIST F&G PROP F&G |
| 15   | FES    | 51+58.6<br>124.2 L |           | (13) 43.0 |          |                        |

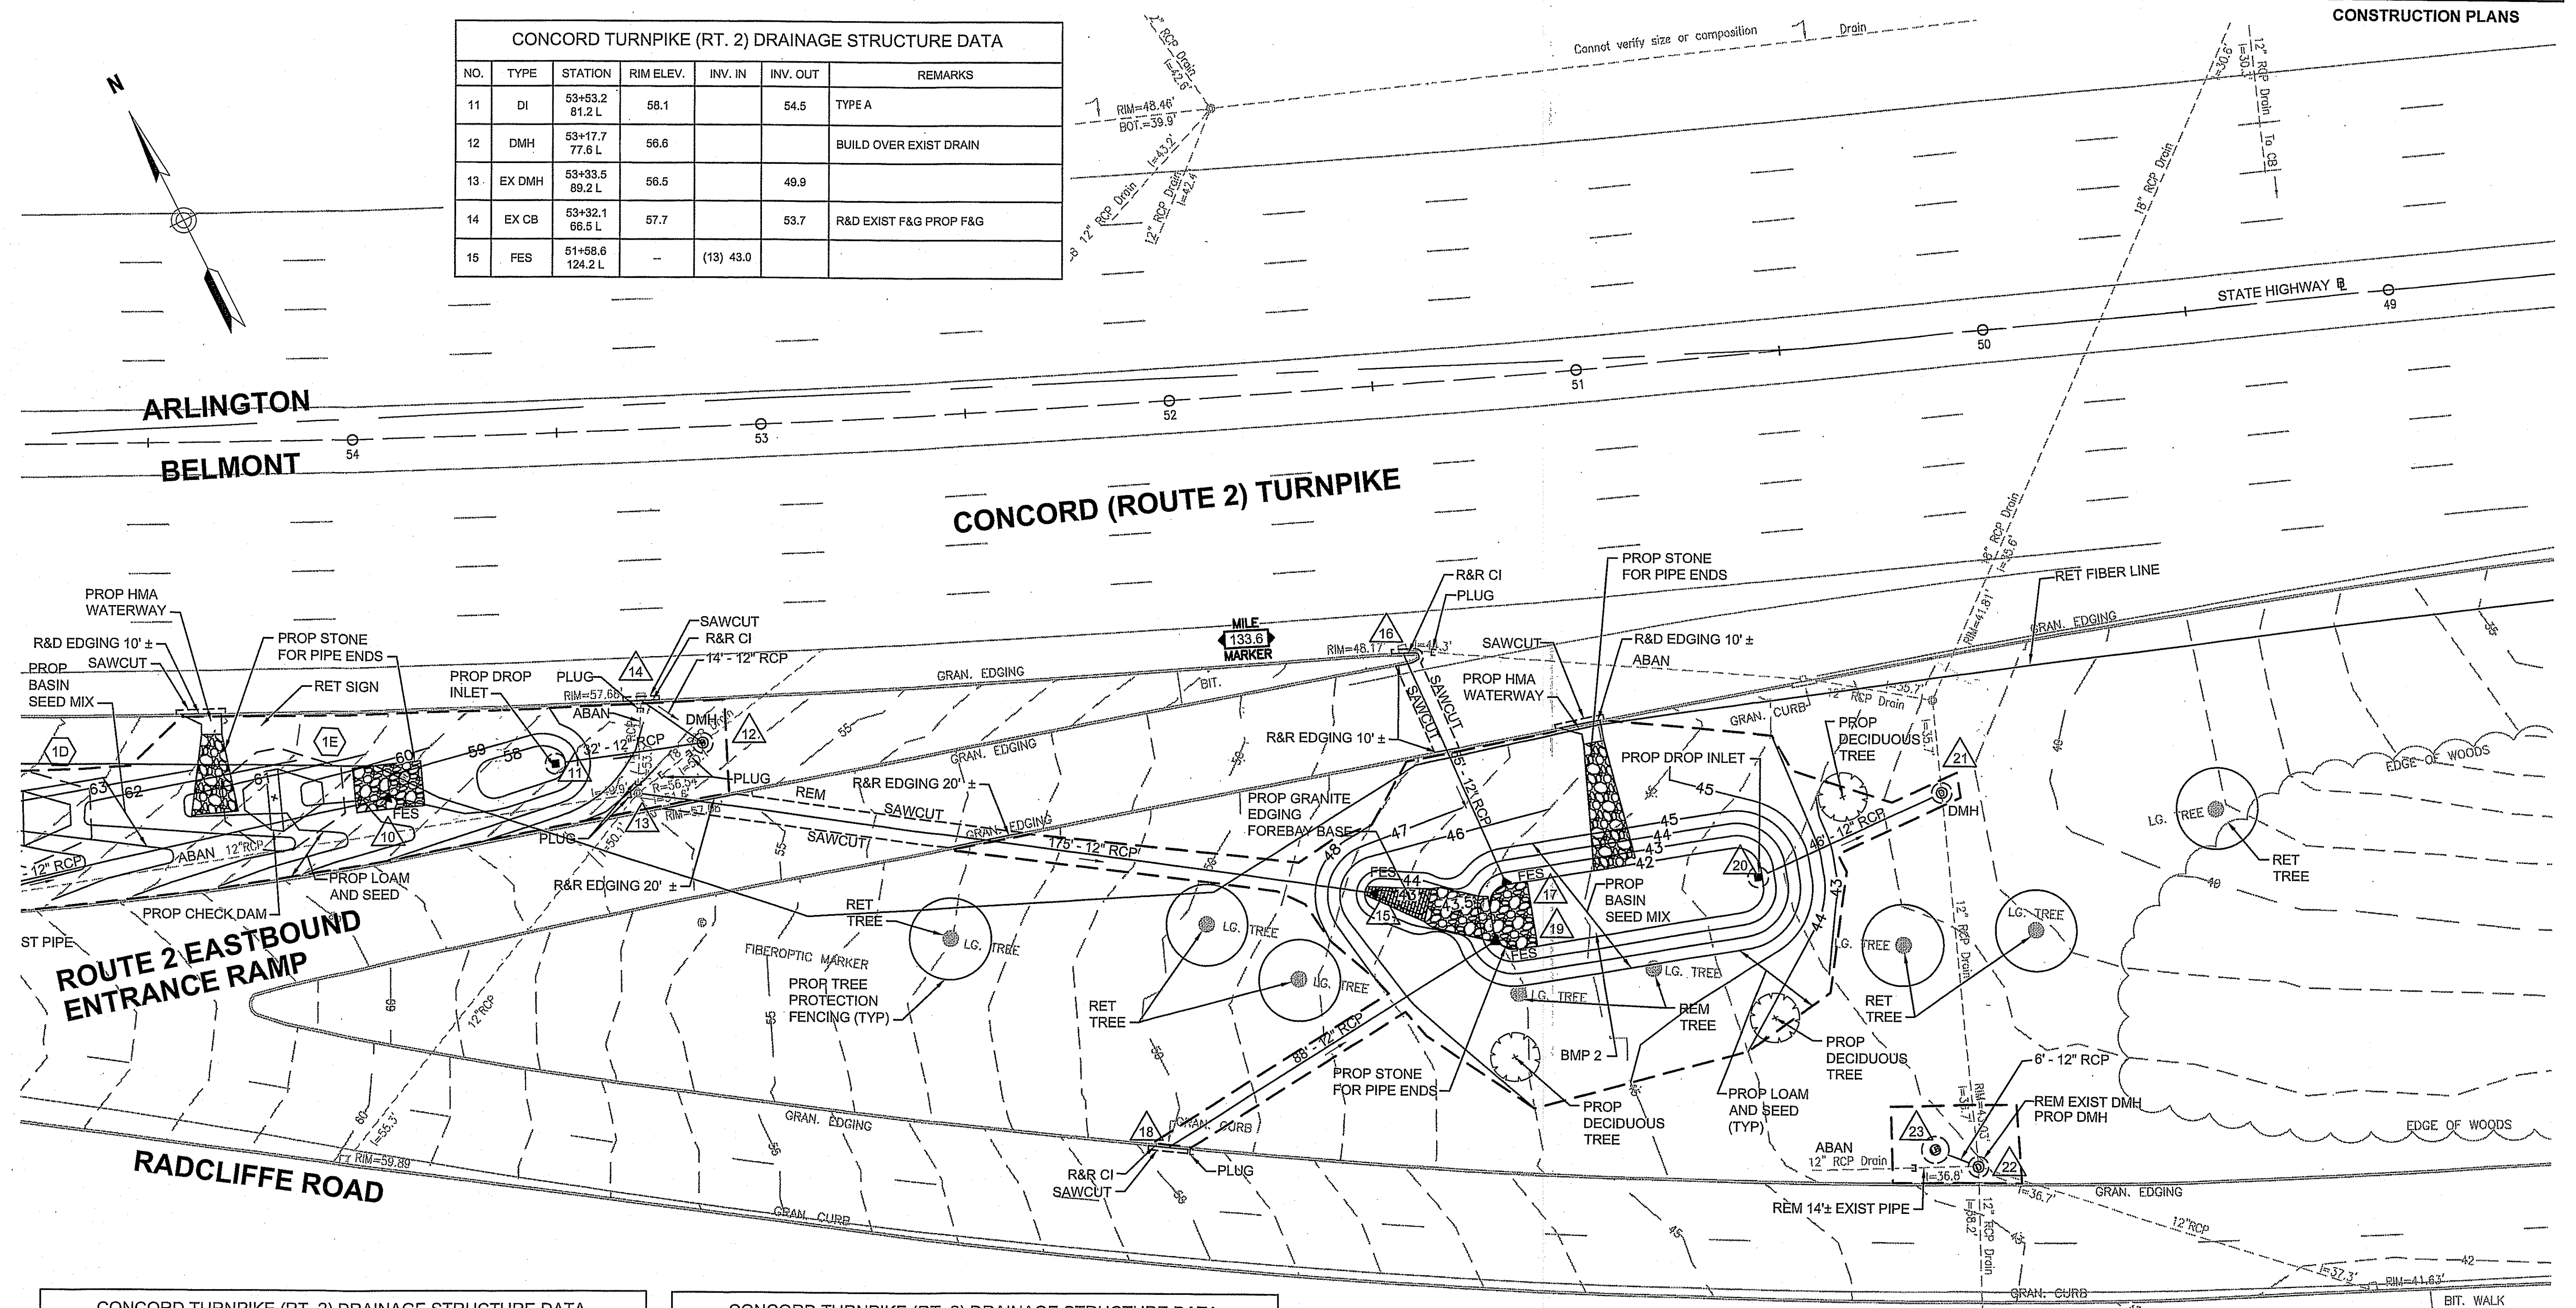

| CONCORD TURNPIKE (RT. 2) DRAINAGE STRUCTURE DATA |       |                    |           |           |          |   |
|--|-------|--------------------|-----------|-----------|----------|---|
| NO.  | TYPE  | STATION            | RIM ELEV. | INV. IN   | INV. OUT | REMARKS   |
| 16   | EX CB | 51+47.8<br>65.8 L  | 48.2      |           | 44.2     | R&D EXIST F&G PROP F&G                                    |
| 17   | FES   | 51+27.6<br>124.3 L |           | (16) 42.0 |          | LENGTH OF STONE FOR PIPE ENDS = FIRST 10' OF BASIN BOTTOM |
| 18   | EX CB | 52+12.4<br>182.7 L | 49.6      |           | 45.6     | R&D EXIST F&G PROP F&G                                    |
| 19   | FES   | 51+31.1<br>137.7 L |           | (18) 42.0 |          | LENGTH OF STONE FOR PIPE ENDS = FIRST 10' OF BASIN BOTTOM |
| 20   | DI    | 50+67.8<br>128.0 L | 43.3      |           | 39.3     | TYPE A  |

| CONCORD TURNPIKE (RT. 2) DRAINAGE STRUCTURE DATA |      |                    |           |           |          |                        |
|--|------|--------------------|-----------|-----------|----------|------------------------|
| NO.  | TYPE | STATION            | RIM ELEV. | INV. IN   | INV. OUT | REMARKS                |
| 21   | DMH  | 50+21.7<br>112.0 L | 41.4      | (20) 37.4 |          | BUILD OVER EXIST DRAIN |
| 22   | DMH  | 50+21.9<br>203.9 L | 43.0      |           | 36.4     |                        |
| 23   | LB   | 50+32.1<br>198.7 L | 43.2      | (22) 36.3 |          |                        |





ARLINGTON - BELMONT (SPY POND)  
DRAINAGE REPAIRS AND IMPROVEMENTS

| STATE            | FED. AID PROJ. NO. | SHEET NO. | TOTAL SHEETS |
|------------------|--------------------|-----------|--------------|
| MA               | (STP)-002S(352)    | 06        | 14           |
| PROJECT FILE NO. |                    | 606280    |              |

CONSTRUCTION PLANS

HIGHWAY GUARD DETAILS

NONE

DRAINAGE DETAILS

SEE BELOW

STATE HIGHWAY R

N CONCORD (ROUTE 2) TURNPIKE

CONCORD (ROUTE 2) TURNPIKE

ROUTE 2 EB ENTRANCE RAMP FROM LAKE ST

LAKE STREET

LAKE STREET

ARLINGTON  
BELMONT

CONCORD TURNPIKE (RT. 2) DRAINAGE STRUCTURE DATA

| NO. | TYPE   | STATION            | RIM ELEV. | INV. IN   | INV. OUT | REMARKS                |
|-----|--------|--------------------|-----------|-----------|----------|------------------------|
| 24  | EX CB  | 44+90.1<br>66.1 L  | 20.3      |           | 14.4     | R&D EXIST F&G PROP F&G |
| 25  | LB     | 45+07.3<br>75.0 L  | 21.5      | (24) 14.3 |          |                        |
| 26  | EX CB  | 43+47.1<br>247.8 L | 35.1      |           | 30.6     | R&D EXIST F&G PROP F&G |
| 27  | LB     | 43+51.4<br>238.5 L | 35.7      | (26) 30.5 |          |                        |
| 28  | DI     | 42+09.8<br>84.4 L  | 16.5      |           | 14.0     | TYPE A                 |
| 29  | EX DMH | 41+18.4<br>79.0 L  | 17.0      | (28) 13.4 |          |                        |

20 0 20 40  
SCALE IN FEET

CONTINUED ON  
SHEET NO. 5

HIGHWAY GUARD DETAILS

NONE

DRAINAGE DETAILS


SEE BELOW

ARLINGTON - BELMONT (SPY POND)  
DRAINAGE REPAIRS AND IMPROVEMENTS

| STATE            | FED. AID PROJ. NO. | SHEET NO. | TOTAL SHEETS |
|------------------|--------------------|-----------|--------------|
| MA               | (STP)-002S(352)    | 07        | 14           |
| PROJECT FILE NO. |                    | 606280    |              |

CONSTRUCTION PLANS

| CONCORD TURNPIKE (RT. 2) DRAINAGE STRUCTURE DATA |       |                   |           |           |          |                        |
|--|-------|-------------------|-----------|-----------|----------|------------------------|
| NO.  | TYPE  | STATION           | RIM ELEV. | INV. IN   | INV. OUT | REMARKS                |
| 31   | EX CB | 27+92.0<br>67.1 R | 22.1      |           | 17.0     | R&D EXIST F&G PROP F&G |
| 32   | LB    | 27+53.5<br>74.1 R | 21.8      | (31) 16.6 |          |                        |
| 33   | EX CB | 25+69.0<br>67.0 R | 24.9      |           | 20.0     | R&D EXIST F&G PROP F&G |
| 34   | LB    | 25+83.2<br>84.4 R | 22.0      | (33) 17.0 |          |                        |

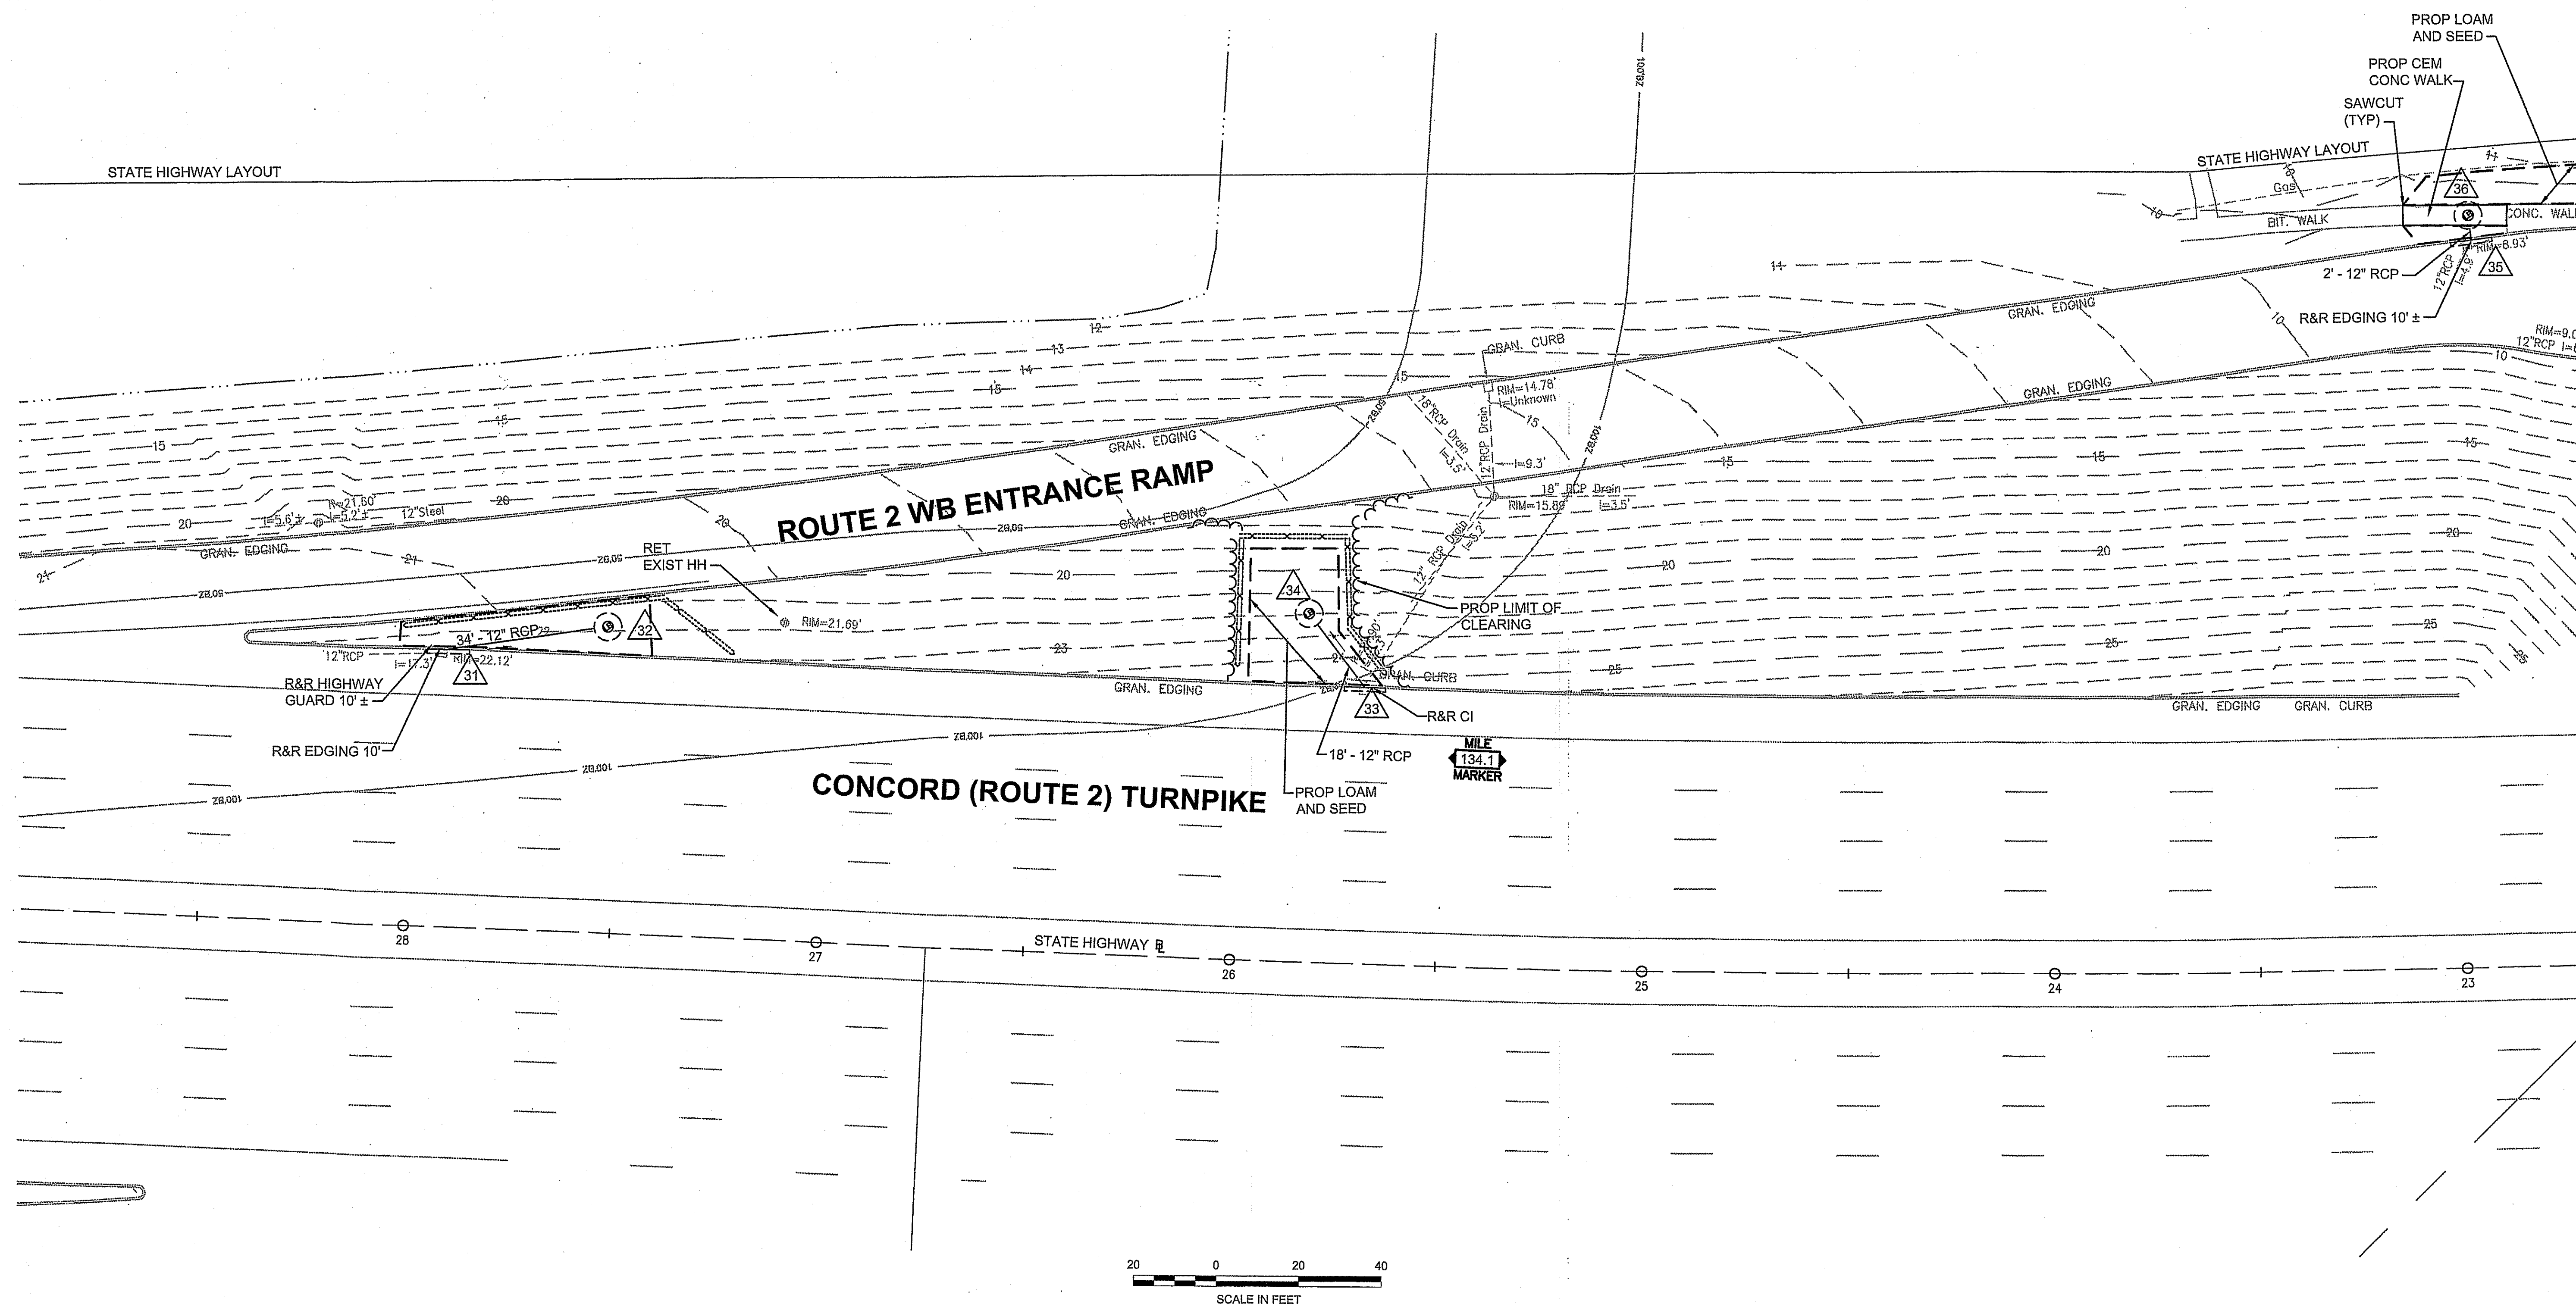

CONTINUED ON  
SHEET NO. 8



HIGHWAY GUARD DETAILS

NONE

DRAINAGE DETAILS


SEE BELOW

ARLINGTON - BELMONT (SPY POND)  
DRAINAGE REPAIRS AND IMPROVEMENTS

| STATE            | FED. AID PROJ. NO. | SHEET NO. | TOTAL SHEETS |
|------------------|--------------------|-----------|--------------|
| MA               | (STP)-002S(352)    | 08        | 14           |
| PROJECT FILE NO. |                    | 606280    |              |

CONSTRUCTION PLANS


| CONCORD TURNPIKE (RT. 2) DRAINAGE STRUCTURE DATA |       |                    |           |          |          |                        |
|--|-------|--------------------|-----------|----------|----------|------------------------|
| NO.  | TYPE  | STATION            | RIM ELEV. | INV. IN  | INV. OUT | REMARKS                |
| 35   | EX CB | 22+93.9<br>176.1 R | 8.9       |          | 4.6      | R&D EXIST F&G PROP F&G |
| 36   | LB    | 22+94.5<br>182.1 R | 9.7       | (36) 4.5 |          |                        |
| 37   | EX CB | 22+43.2<br>177.8 R | 9.0       |          | 4.6      | R&D EXIST F&G PROP F&G |
| 38   | LB    | 22+45.0<br>184.1 R | 9.6       | (37) 4.5 |          |                        |

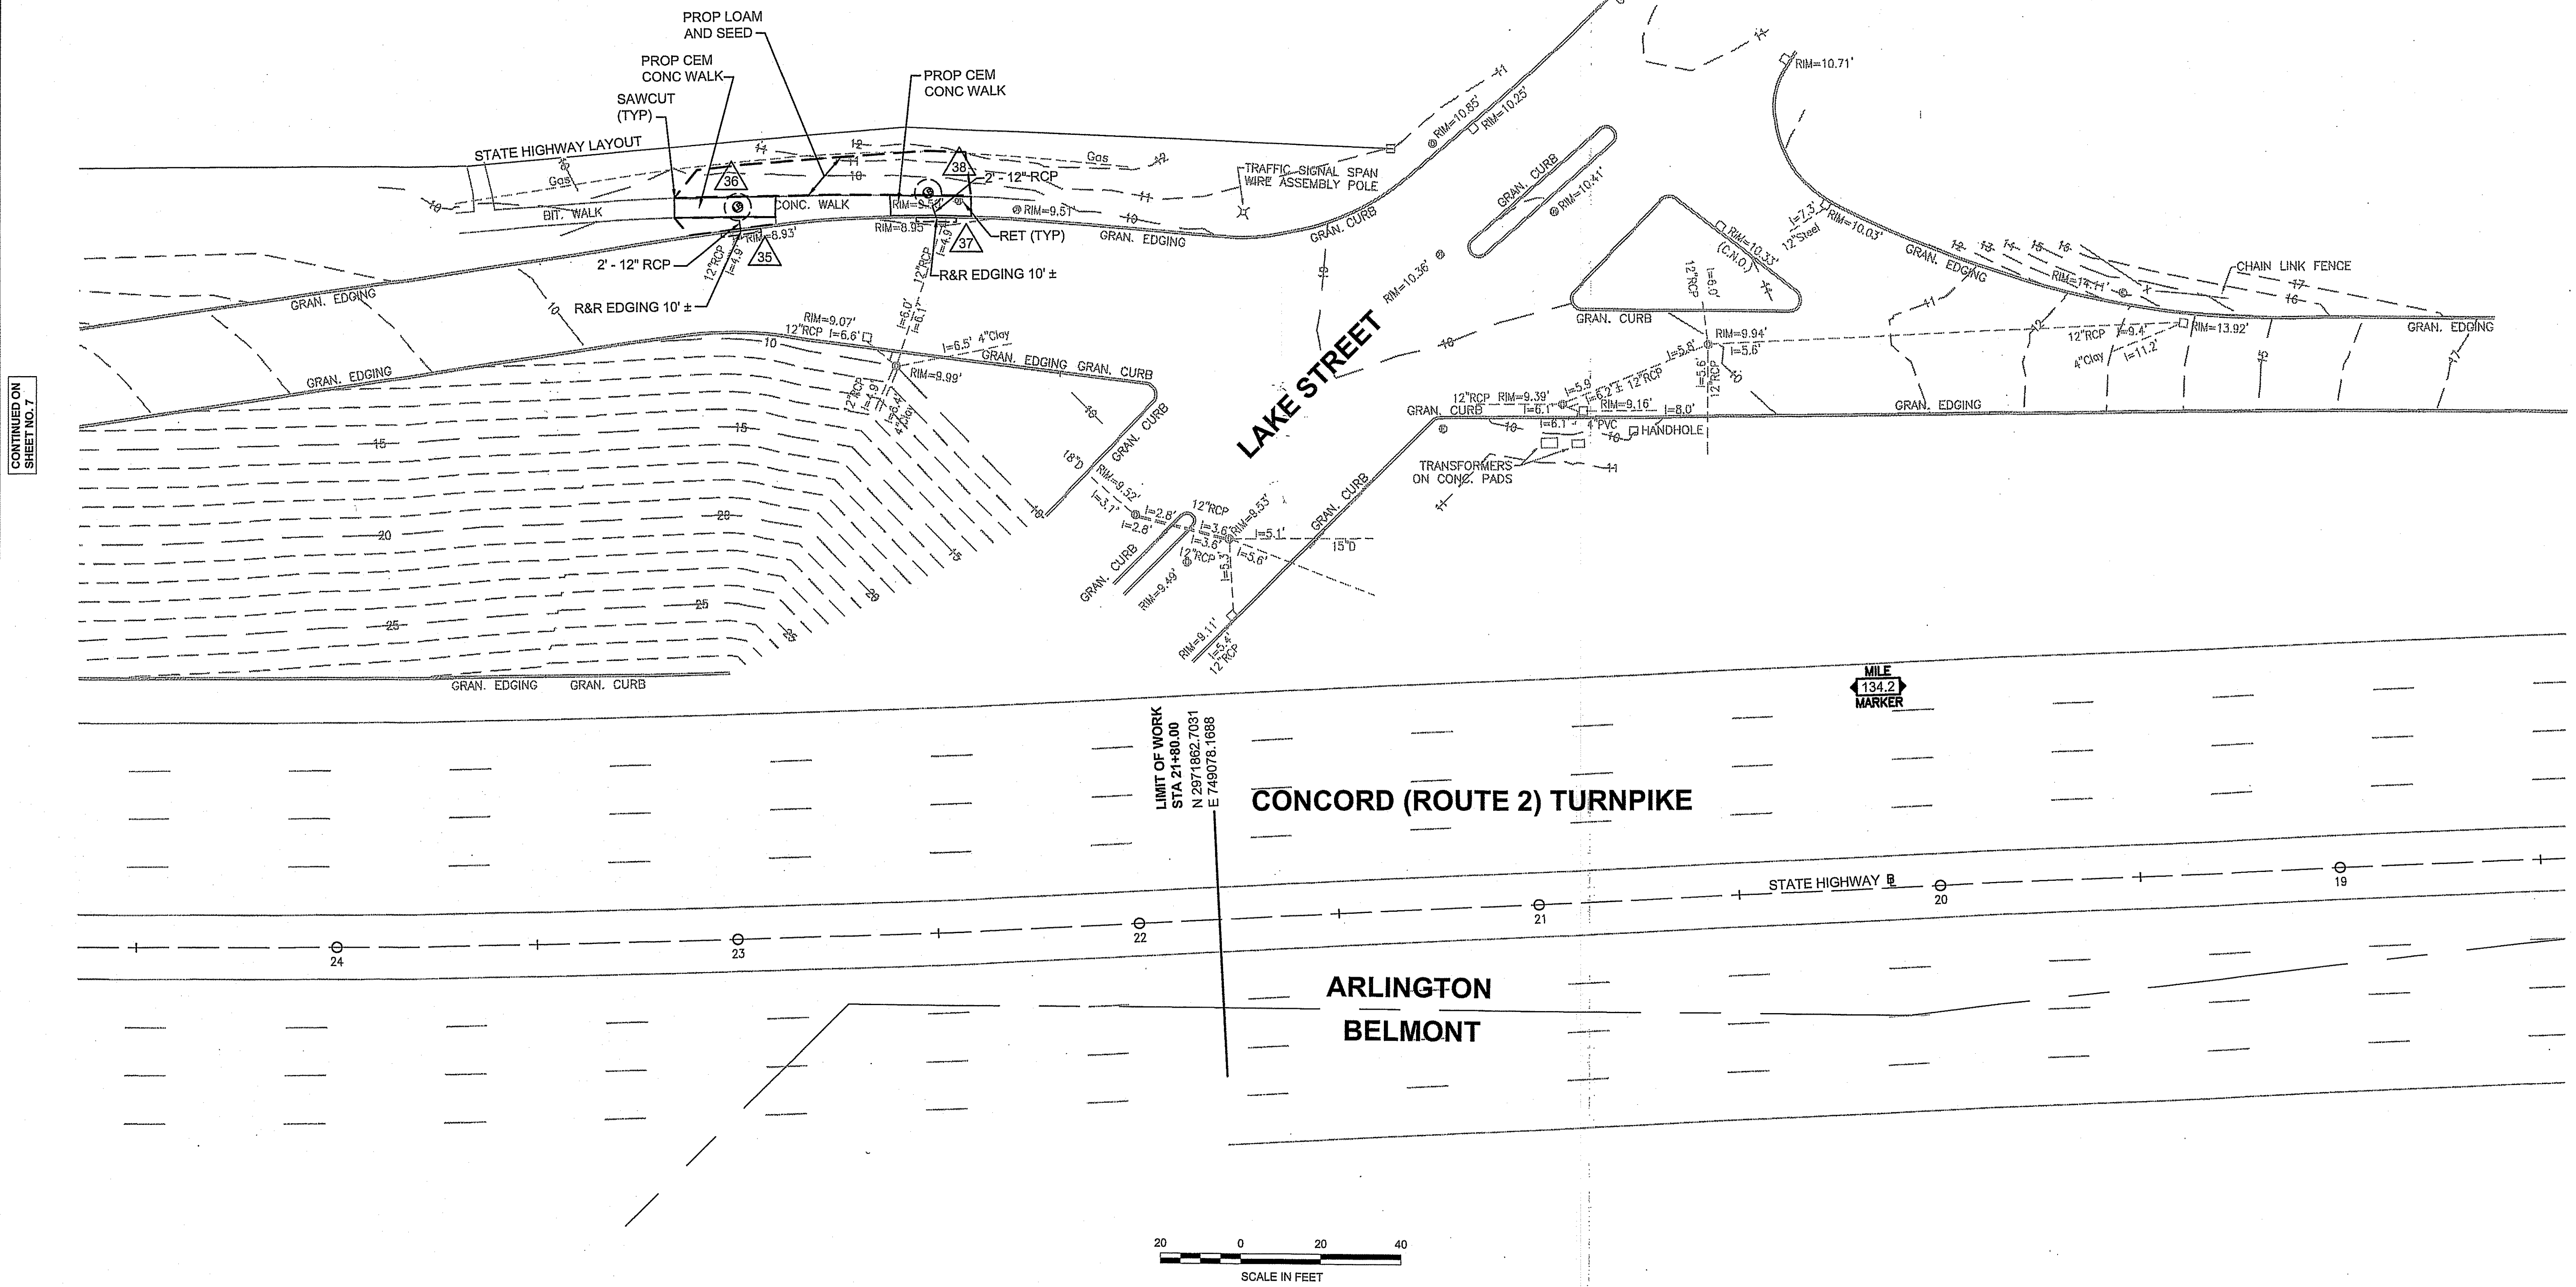

CONTINUED ON  
SHEET NO. 7




## OPERATIONAL SIGNING

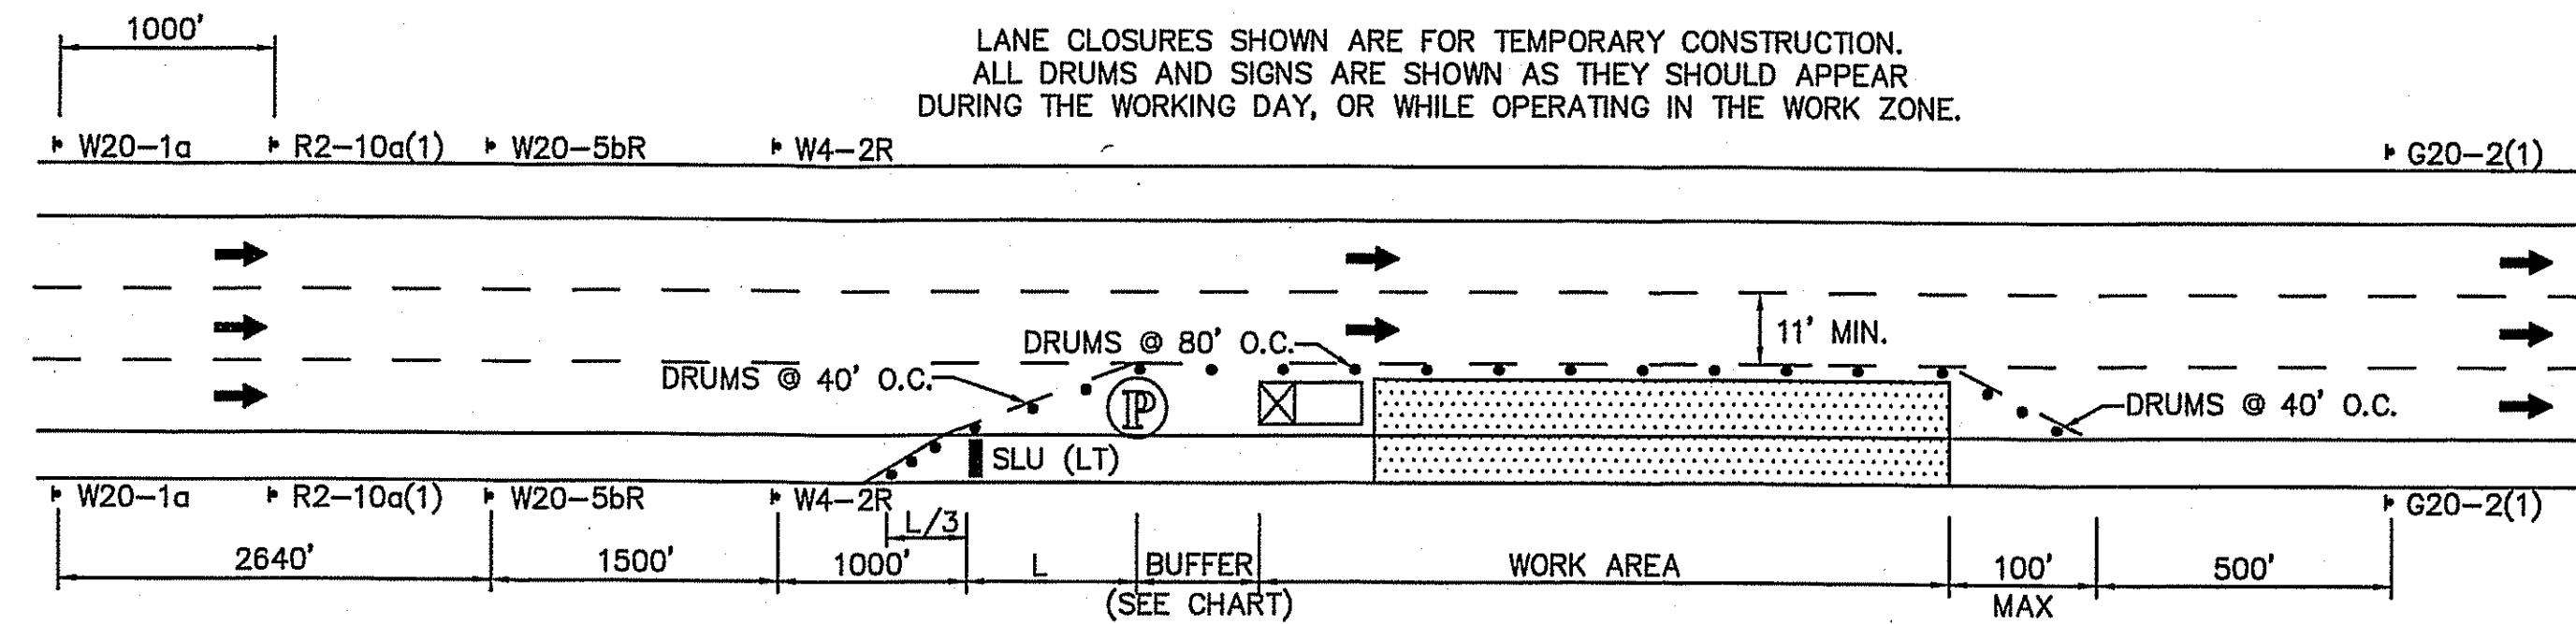


## ONE LANE CLOSURE - RIGHT

NOT TO SCALE

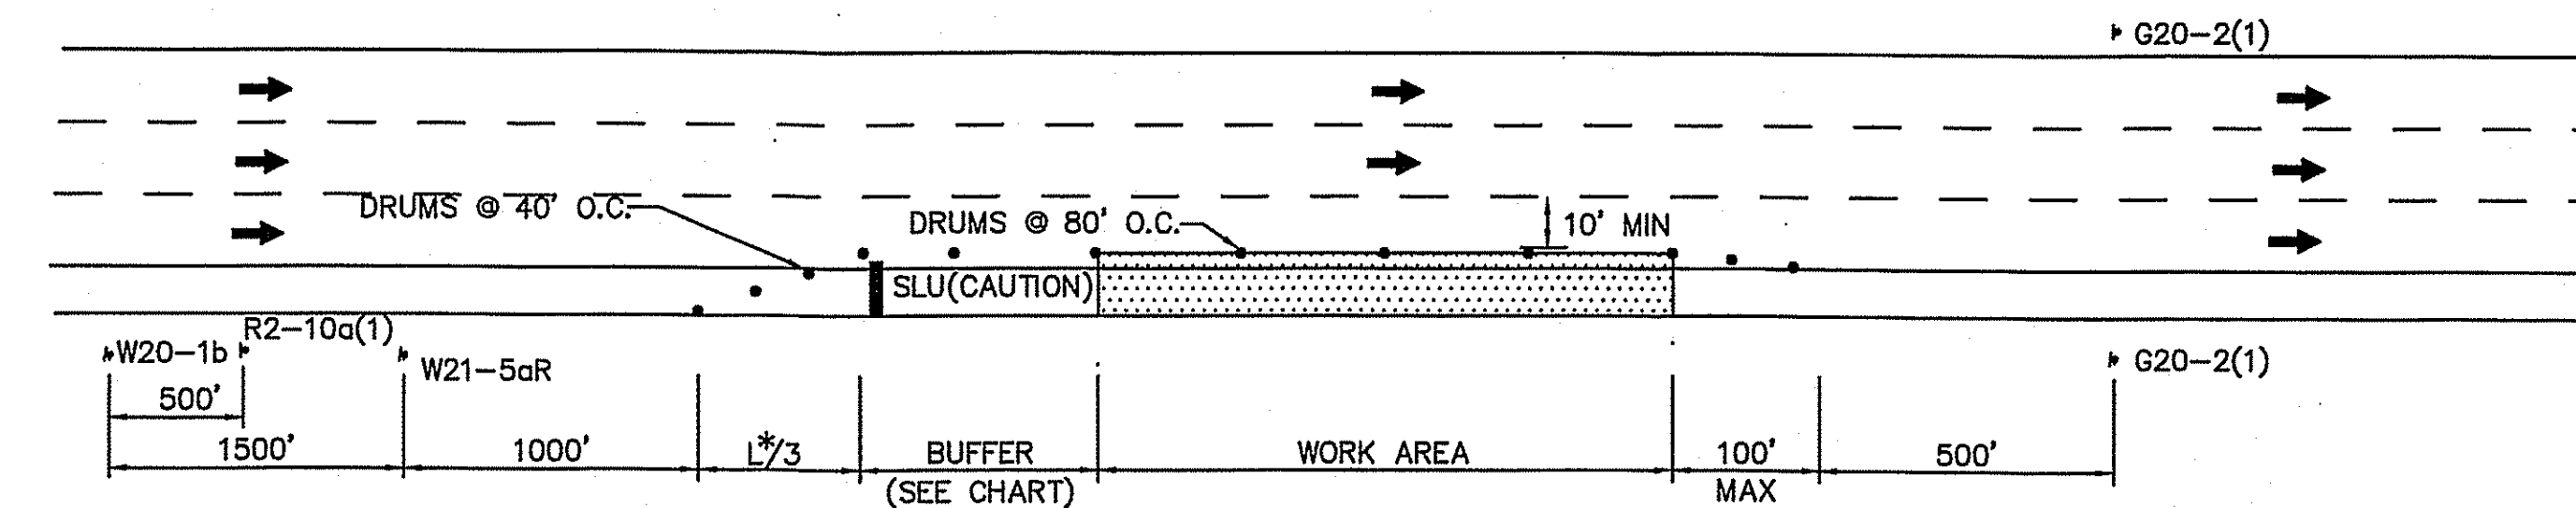

## RIGHT SHOULDER CLOSURE WITH MINOR ENCROACHMENT

NOT TO SCALE

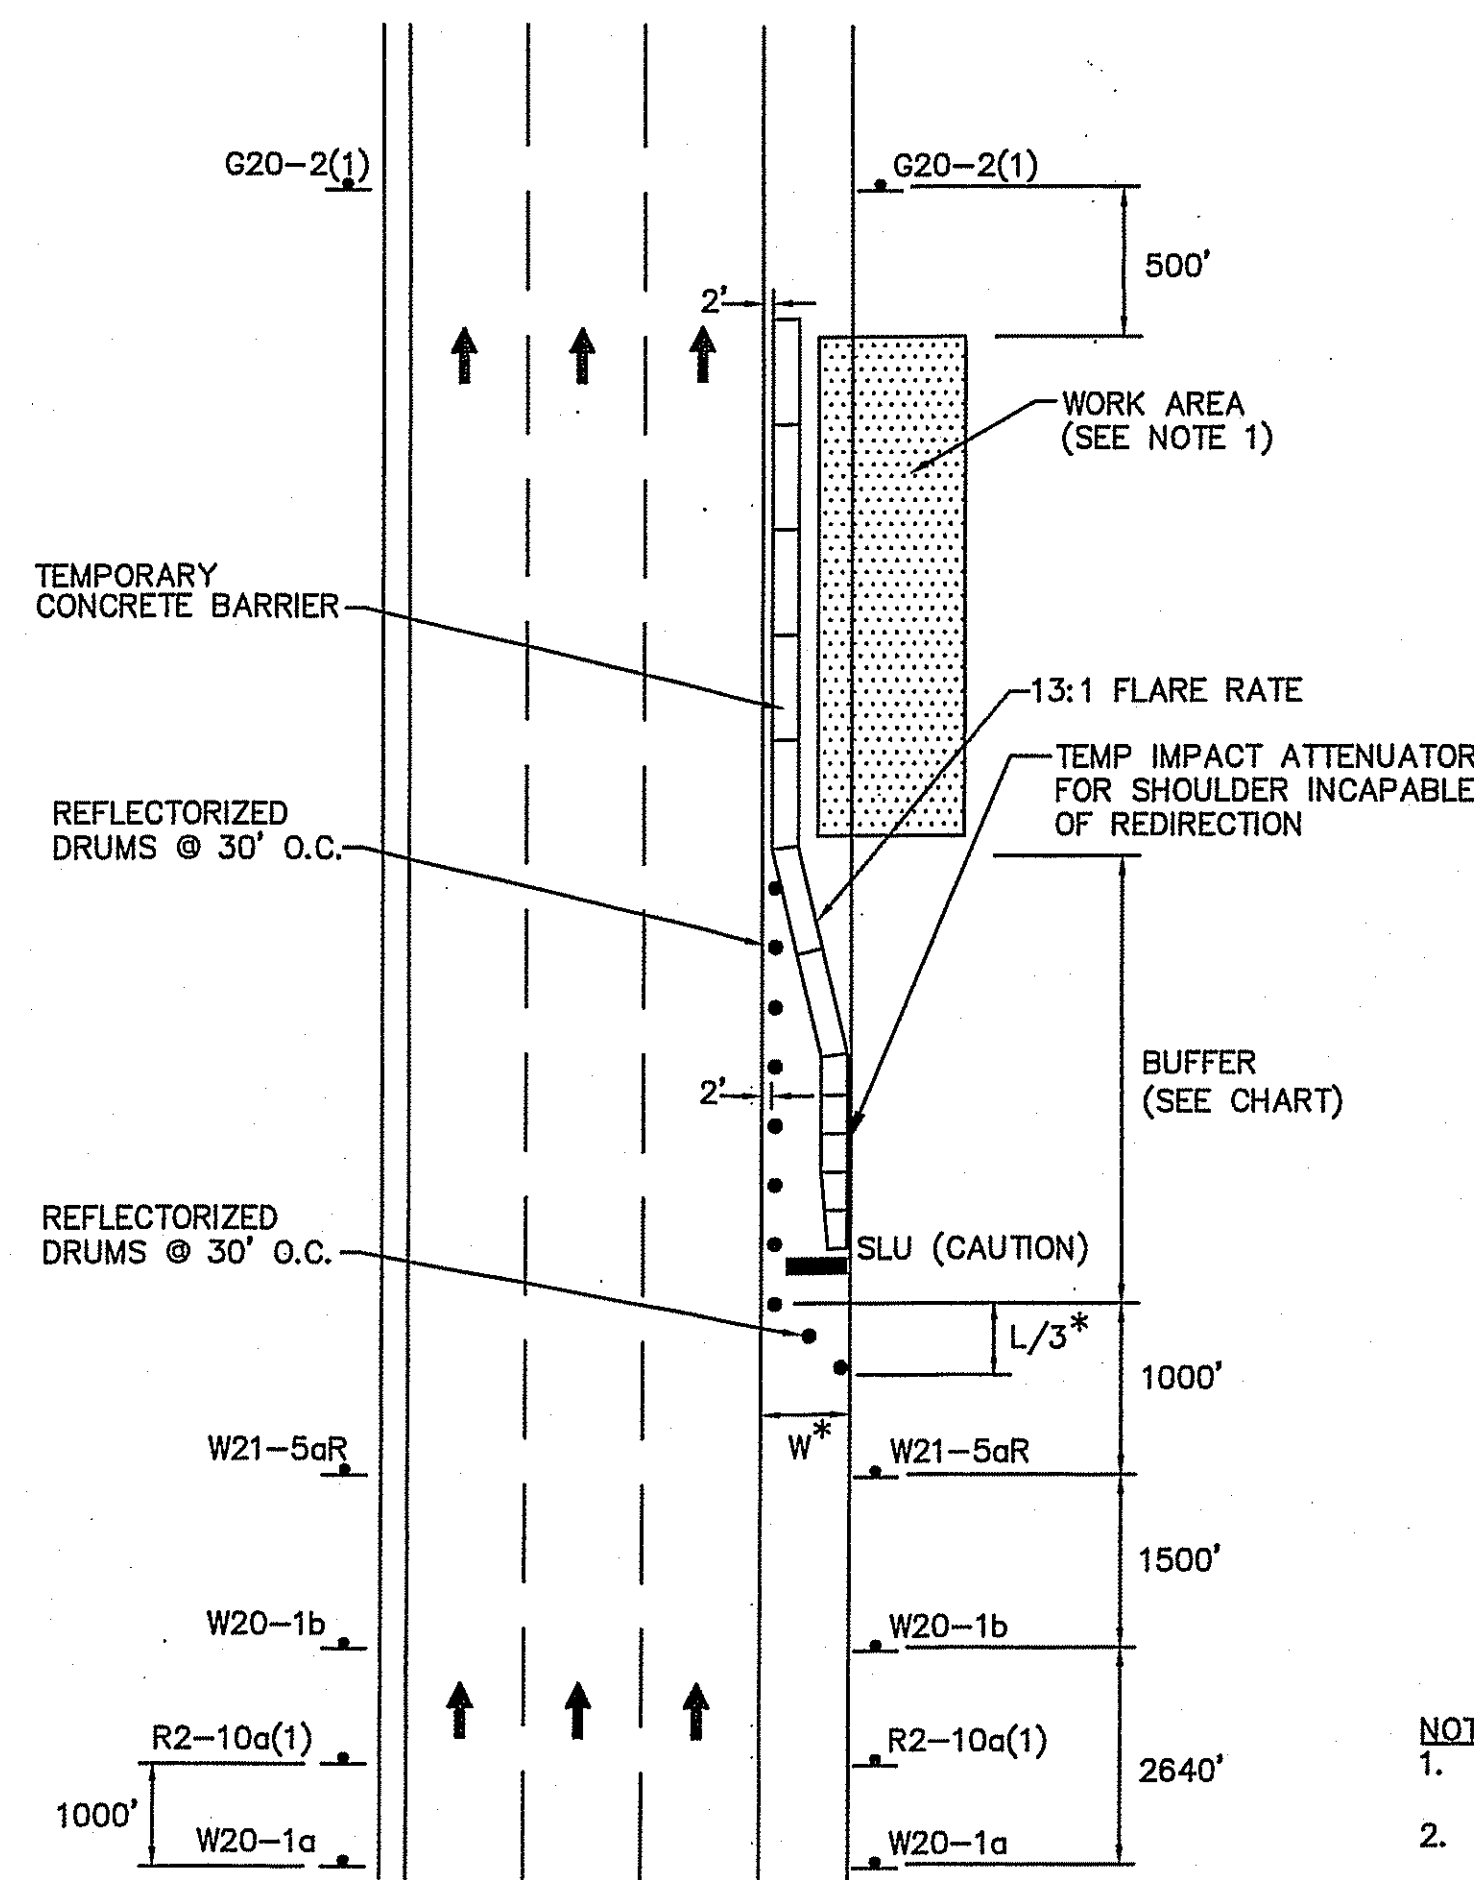


## RIGHT SHOULDER CLOSED WITH BARRIER

NOT TO SCALE

- NOTES:
1. ALL BLUNT ENDS OF BARRIER SHALL BE PROTECTED AT ALL TIMES IN ACCORDANCE WITH THE LATEST EDITION OF THE AASHTO ROADSIDE DESIGN GUIDE.
  2. TEMPORARY IMPACT ATTENUATORS SHALL BE DESIGNED FOR TEST LEVEL 3 (TL-3) ON ROADWAYS HAVING A POSTED SPEED IN EXCESS OF 45 MPH.
  3. LEVEL ASPHALT CLEAR SLIDE SPACE FOR BARRIER SHALL BE FREE FROM OBSTRUCTIONS AT ALL TIMES. 3 FEET CLEAR SHALL BE PROVIDED FOR SPEEDS LESS THAN OR EQUAL TO 45 MPH. 5 FEET CLEAR SHALL BE PROVIDED FOR SPEEDS IN EXCESS OF 45 MPH.
  4. IF MINIMUM CLEAR SLIDE SPACE CANNOT BE PROVIDED TEMP CONC BARRIER SHALL BE ANCHORED OR RESTRAINED BY A MASSDOT AND FHWA APPROVED METHOD.
  5. TEMP IMPACT ATTENUATOR SHALL BE INSTALLED IN ACCORDANCE WITH MANUFACTURERS RECOMMENDATIONS.

## LEGEND

- DRUM
- ▲ TRAFFIC CONE
- Ⓟ POLICE OFFICER
- Ⓡ FLAGGER
- CONSTRUCTION SIGN
- ⓧ MOVABLE IMPACT ATTENUATOR
- ⓧ TYPE III BARRICADES
- WORK AREA PUBLIC ACCESS RESTRICTED
- ← PROPOSED TRAFFIC FLOW
- NTS NOT TO SCALE
- PORTABLE CHANGEABLE MESSAGE SIGN (PCMS)
- DETOUR ROUTE

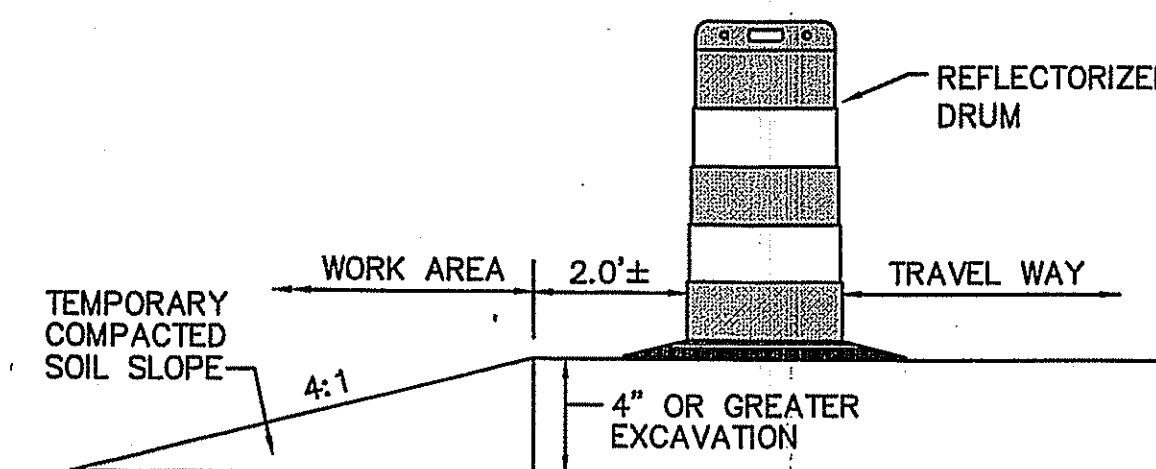

## ROADWAY SLOPE PROTECTION

NOT TO SCALE

### FOR POSTED SPEEDS GREATER THAN 40 MPH

- \*  $L = W \times S$  L=TAPER LENGTH  
W=WIDTH OF ROADWAY TO BE SHIFTED OR REDIRECTED  
S=POSTED SPEED LIMIT

### FOR POSTED SPEEDS OF 40 MPH OR LESS

- \*  $L = \frac{WS^2}{60}$  L=TAPER LENGTH  
W=WIDTH OF ROADWAY TO BE SHIFTED OR REDIRECTED  
S=POSTED SPEED LIMIT

### BUFFER SPACING

| SPEED (MPH) | DISTANCE (FEET) |
|-------------|-----------------|
| 15          | 80              |
| 20          | 115             |
| 25          | 155             |
| 30          | 200             |
| 35          | 250             |
| 40          | 305             |
| 45          | 360             |
| 50          | 425             |
| 55          | 495             |
| 60          | 570             |
| 65          | 645             |

## ARLINGTON - BELMONT (SPY POND) DRAINAGE REPAIRS AND IMPROVEMENTS

| STATE            | FED. AID PROJ. NO. | SHEET NO. | TOTAL SHEETS |
|------------------|--------------------|-----------|--------------|
| MA               | (STP)-002S(352)    | 09        | 14           |
| PROJECT FILE NO. |                    | 606280    |              |

## TEMPORARY TRAFFIC CONTROL PLANS


## GENERAL NOTES

1. ALL CONSTRUCTION SIGNING, TEMPORARY TRAFFIC CONTROL DEVICES, AND ROADSIDE ELEMENTS SHALL CONFORM WITH THE LATEST VERSION OF THE MANUAL ON UNIFORM TRAFFIC CONTROL DEVICES (MUTCD) AS AMENDED, THE LATEST REVISIONS OF THE AMERICAN ASSOCIATION OF STATE HIGHWAY AND TRANSPORTATION OFFICIALS, (AASHTO) ROADSIDE DESIGN GUIDE, AASHTO POLICY ON GEOMETRIC DESIGN OF HIGHWAYS AND STREETS, AND NATIONAL COOPERATIVE HIGHWAY RESEARCH PROGRAM (NCHRP) REPORT 350 OR THE AASHTO MANUAL FOR ASSESSING SAFETY HARDWARE (MASH).
2. WORK HOURS SHALL BE 9:00AM TO 3:00PM MONDAY THRU FRIDAY UNLESS OTHERWISE APPROVED BY THE ENGINEER. WORK SHALL NOT AFFECT TRAFFIC PATTERNS DURING PEAK TRAFFIC PERIODS. PEAK TRAFFIC PERIODS ARE DEFINED AS MONDAY THRU FRIDAY 7:00AM-9:00AM AND 3:00PM-6:00PM.
3. ALL DRUMS SHALL BE SET AT 40' ON CENTER MAX. UNLESS OTHERWISE NOTED OR ADJUSTED BY THE ENGINEER.
4. ALL DRUMS SHALL BE APPROXIMATELY PLACED AND MOVED AS NECESSARY TO MAINTAIN ADEQUATE ABUTTER ACCESS AT ALL TIMES. WORK MAY REQUIRE ADDITIONAL SIGNS, DRUMS AND OTHER TRAFFIC CONTROL DEVICES, GRADING AND TEMPORARY PAVEMENT FOR PASSAGE OF PEDESTRIAN, VEHICULAR AND EMERGENCY TRAFFIC THROUGH THE WORK AREAS, BOTH DURING AND AFTER WORKING HOURS, TO MAINTAIN SUCH ACCESS.
5. GRADE SEPARATIONS IN EXCESS OF 2" DURING NON-WORKING HOURS WILL REQUIRE DELINEATION BY USE OF DRUMS.
6. EXCAVATION EDGES IN EXCESS OF 4 INCHES DEEP SHALL BE PROTECTED DURING NON-WORKING HOURS BY BACKFILLING WITH A WEDGE OF COMPACTED GRAVEL BORROW AT A 4:1 SLOPE PER THE DETAIL SHOWN. EXCAVATIONS IN EXCESS OF 2 FEET SHOULD BE PROTECTED BY A MASSDOT APPROVED TEMPORARY CONCRETE BARRIER WITH A MINIMUM LATERAL OFFSET OF 3 FEET FROM THE EDGE OF EXCAVATION. BARRIER PLACED WITH LESS THAN THE RECOMMENDED LATERAL OFFSET TO THE EDGE OF EXCAVATION SHALL BE ANCHORED/RESTRAINED BY A MASSDOT AND FHWA APPROVED METHOD TO PREVENT LATERAL MOVEMENT WHEN STRUCK BY ERRANT VEHICLES TRAVELING AT THE POSTED SPEED.
7. THE CONTRACTOR SHALL PROVIDE TEMPORARY IMPACT ATTENUATORS TO PROTECT ALL BLUNT-ENDS OF TEMPORARY CONCRETE BARRIER, OR AS REQUIRED ON THE TRAFFIC MANAGEMENT PLANS. TEMPORARY IMPACT ATTENUATORS SHALL BE DESIGNED BY THE CONTRACTOR AND SUBMITTED TO THE ENGINEER FOR APPROVAL PRIOR TO THE START OF WORK. ALL TEMPORARY IMPACT ATTENUATORS SHALL BE DESIGNED FOR TEST LEVEL 2 (TL-2) ON ALL ROADWAYS HAVING A POSTED SPEED LESS THAN 45MPH AND TEST LEVEL 3 (TL-3) ON ROADWAYS HAVING A POSTED SPEED IN EXCESS OF 45MPH.
8. CONTRACTOR SHALL HAVE MOVEABLE IMPACT ATTENUATORS (1 PER CLOSED LANE) WITHIN AND IN ADVANCE OF THE WORK AREA FOR ALL TEMPORARY WORK ZONES ON RTE 2, OR AS DIRECTED BY THE ENGINEER.
9. 11' MINIMUM LANE WIDTHS SHALL BE MAINTAINED UNLESS OTHERWISE NOTED ON PLANS OR ADJUSTED BY THE ENGINEER.
10. TRAFFIC CONTROL DEVICES AND SIGNS SHALL BE COVERED OR REMOVED DURING NON-WORKING HOURS WHEN NOT IN USE.
11. ADVISORY SPEED PLATES (W13-1P) SHALL BE USED IF APPROPRIATE AND AS REQUESTED BY THE ENGINEER. ADVISORY SPEED SHALL BE AS ESTABLISHED BY THE MASSDOT DISTRICT 4 OFFICE.
12. SIGNS INSTALLED ON PORTABLE STANDS REQUIRE 12 INCH MINIMUM MOUNTING HEIGHT FROM THE ROADWAY SURFACE TO THE BOTTOM OF THE SIGN.
13. SIGNS INSTALLED ON PORTABLE STANDS PLACED AMONG CHANNELIZATION DEVICES REQUIRE A 36 INCH MINIMUM MOUNTING HEIGHT FROM THE ROADWAY SURFACE TO THE BOTTOM OF THE SIGN.
14. SIGNS MOUNTED ON POSTS REQUIRE A MINIMUM 84 INCH MOUNTING HEIGHT FROM THE ROADWAY OR SIDEWALK SURFACE TO THE BOTTOM OF THE SIGN.
15. W20-8 SIGNS SHALL BE REPLACED BY W20-7a SIGNS WHEN FLAGGERS ARE USED IN LIEU OF POLICE OFFICER DETAILS.
16. IMPACT ATTENUATORS ON RTE 2 SHALL BE DESIGNED TO MEET THE CRITERIA FOR TEST LEVEL 3 OF NCHRP 350 OR MASH.
17. TEMPORARY TRAFFIC CONTROL DEVICES ON TAPERS AND AT ROADWAY/RAMP CLOSURE LOCATIONS SHALL BE REFLECTORIZED DRUMS.
18. REFLECTORIZED CONES SHALL BE A MINIMUM OF 36 INCHES IN HEIGHT.
19. CONES MAY BE USED IN LIEU OF DRUMS OUTSIDE OF TAPER AREAS.
20. PROVIDE CLEAR ZONES AROUND MOVEABLE IMPACT ATTENUATOR DEVICES AS REQUIRED BY THE THE MANUFACTURER.
21. POLICE DETAILS ARE REQUIRED IN EACH CLOSED LANE OF RTE 2 IN ACCORDANCE WITH MASSDOT STANDARDS.
22. CONTRACTOR MAY CLOSE ONE (1) LANE ON RTE 2 BETWEEN THE HOURS OF 9 AM TO 3 PM MONDAY THROUGH FRIDAY, UNLESS OTHERWISE APPROVED BY DISTRICT 4 PERMIT ENGINEER.
23. AT NO TIME SHALL ANY HAZARD PROTECTED BY GUARDRAIL OR BARRIER BE EXPOSED TO TRAFFIC. ANY GUARDRAIL OR BARRIER REMOVED TO COMPLETE THE WORK SHALL BE RESTORED AT THE END OF THE WORKING DAY OR PROTECTED BY BARRIER (SEE DETAIL) PRIOR TO EXPOSING THE HAZARD AREA TO TRAFFIC.
24. A PORTABLE CHANGEABLE MESSAGE SIGN SHALL BE USED IF APPROPRIATE AND AS DIRECTED BY THE ENGINEER.
25. SLU FLASHING CAUTION SHALL FLASH IN FOUR-POINT CAUTION MODE ONLY.
26. CONTRACTOR SHALL SECURE WORK ZONE TO PREVENT UNAUTHORIZED ACCESS AT ALL TIMES.

ARLINGTON - BELMONT (SPY POND)  
DRAINAGE REPAIRS AND IMPROVEMENTS


| STATE            | FED. AID PROJ. NO. | SHEET NO. | TOTAL SHEETS |
|------------------|--------------------|-----------|--------------|
| MA               | (STP)-002S(352)    | 10        | 14           |
| PROJECT FILE NO. |                    | 606280    |              |

TEMPORARY TRAFFIC CONTROL PLANS

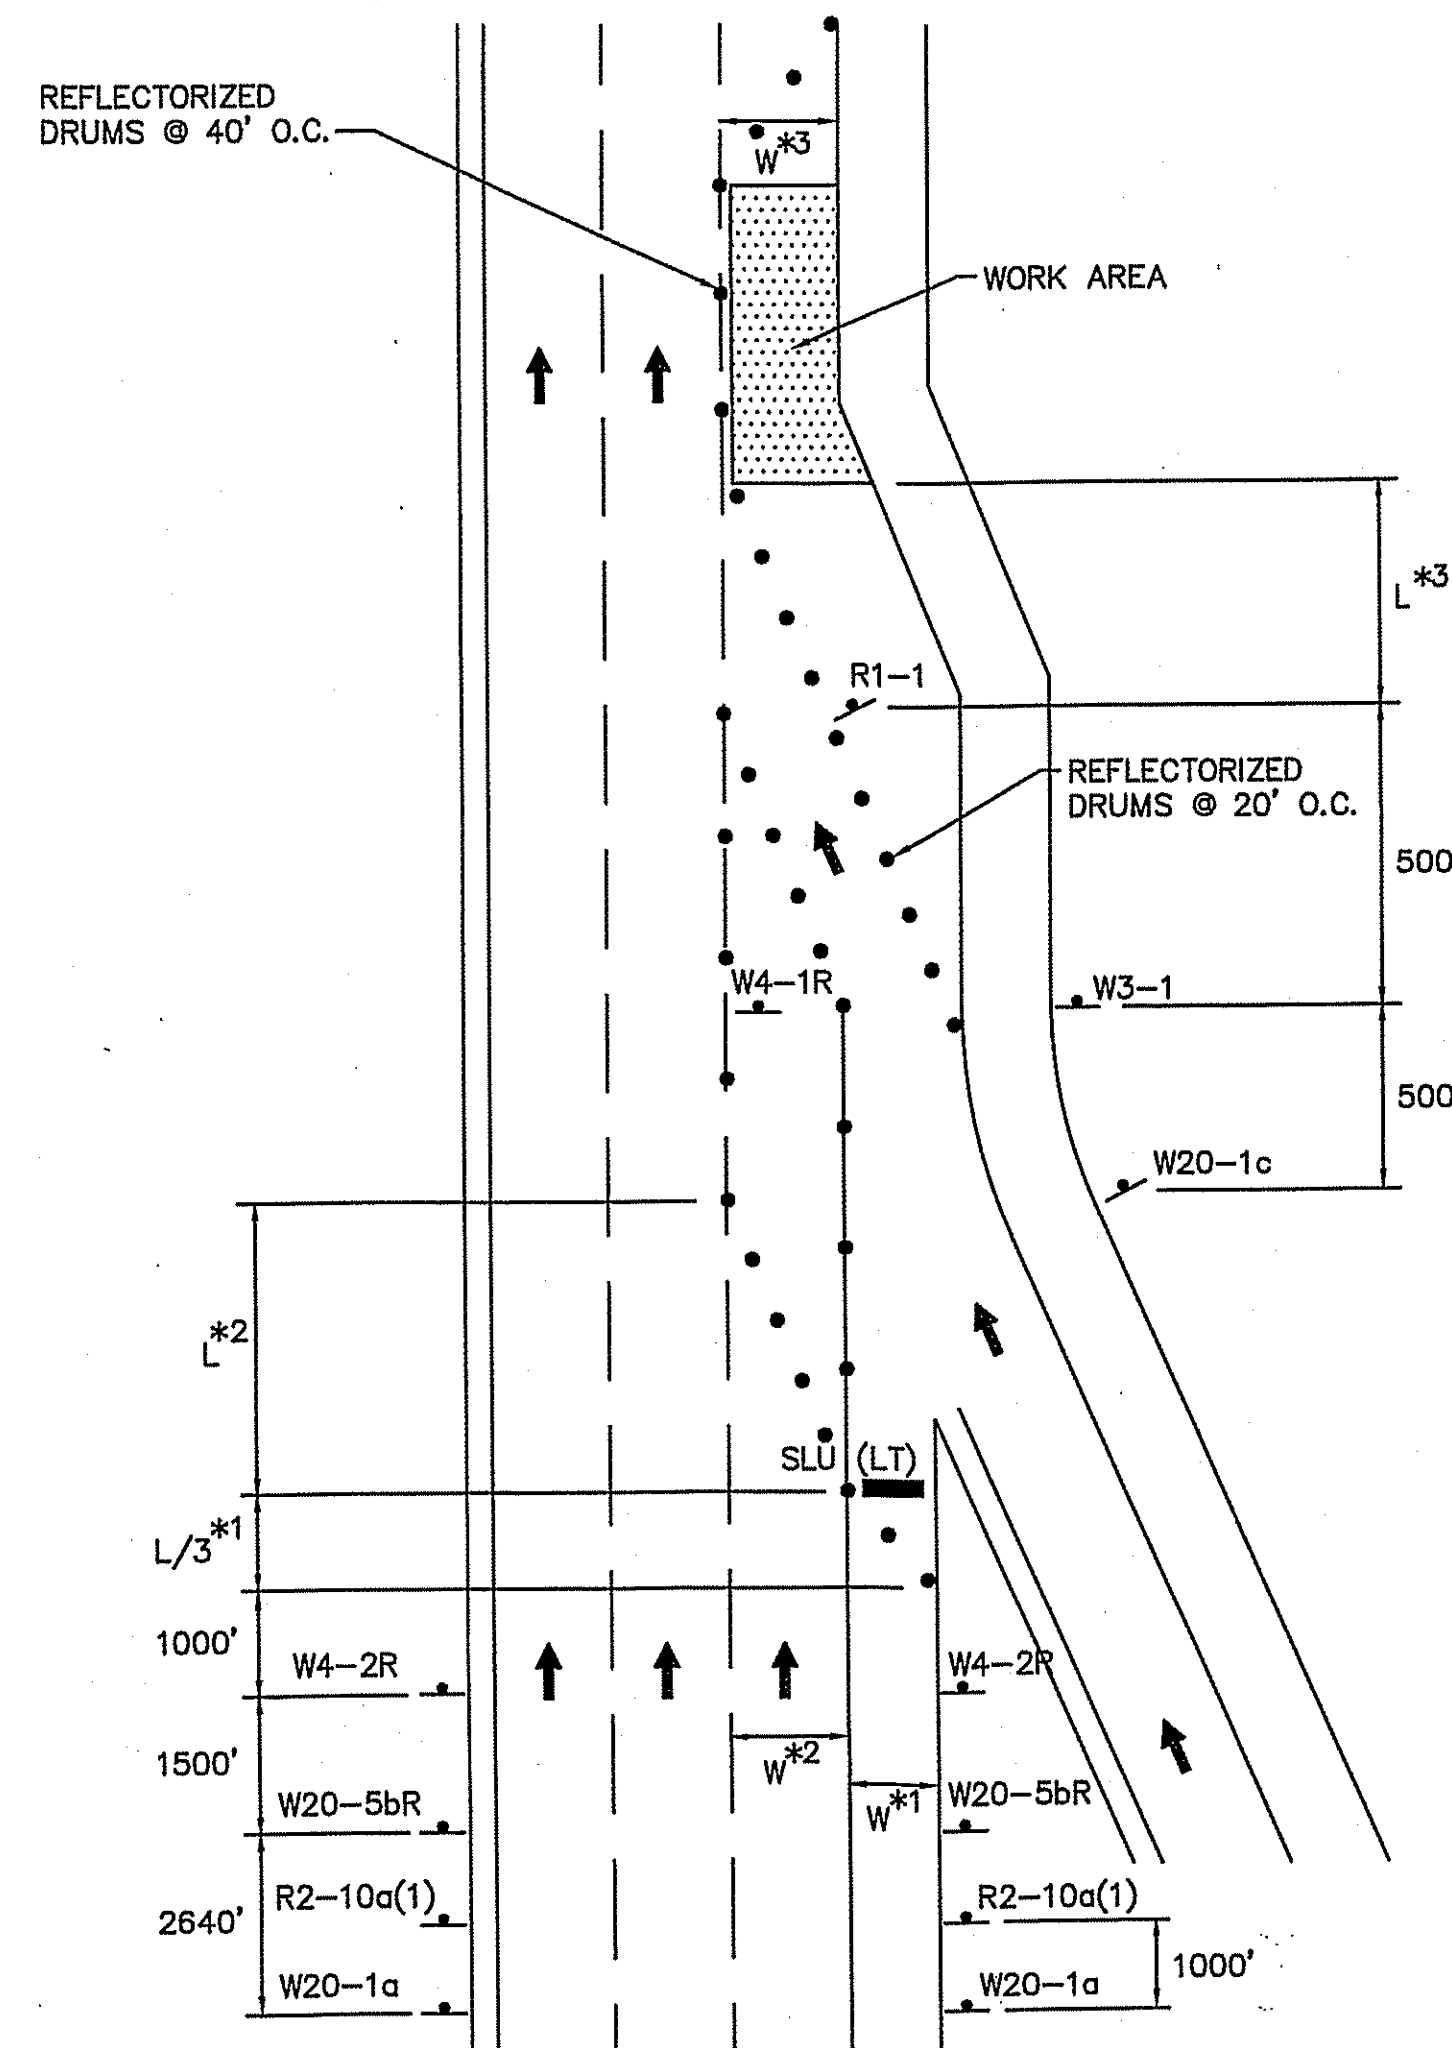


WORK BEYOND ENTRANCE RAMP

NOT TO SCALE

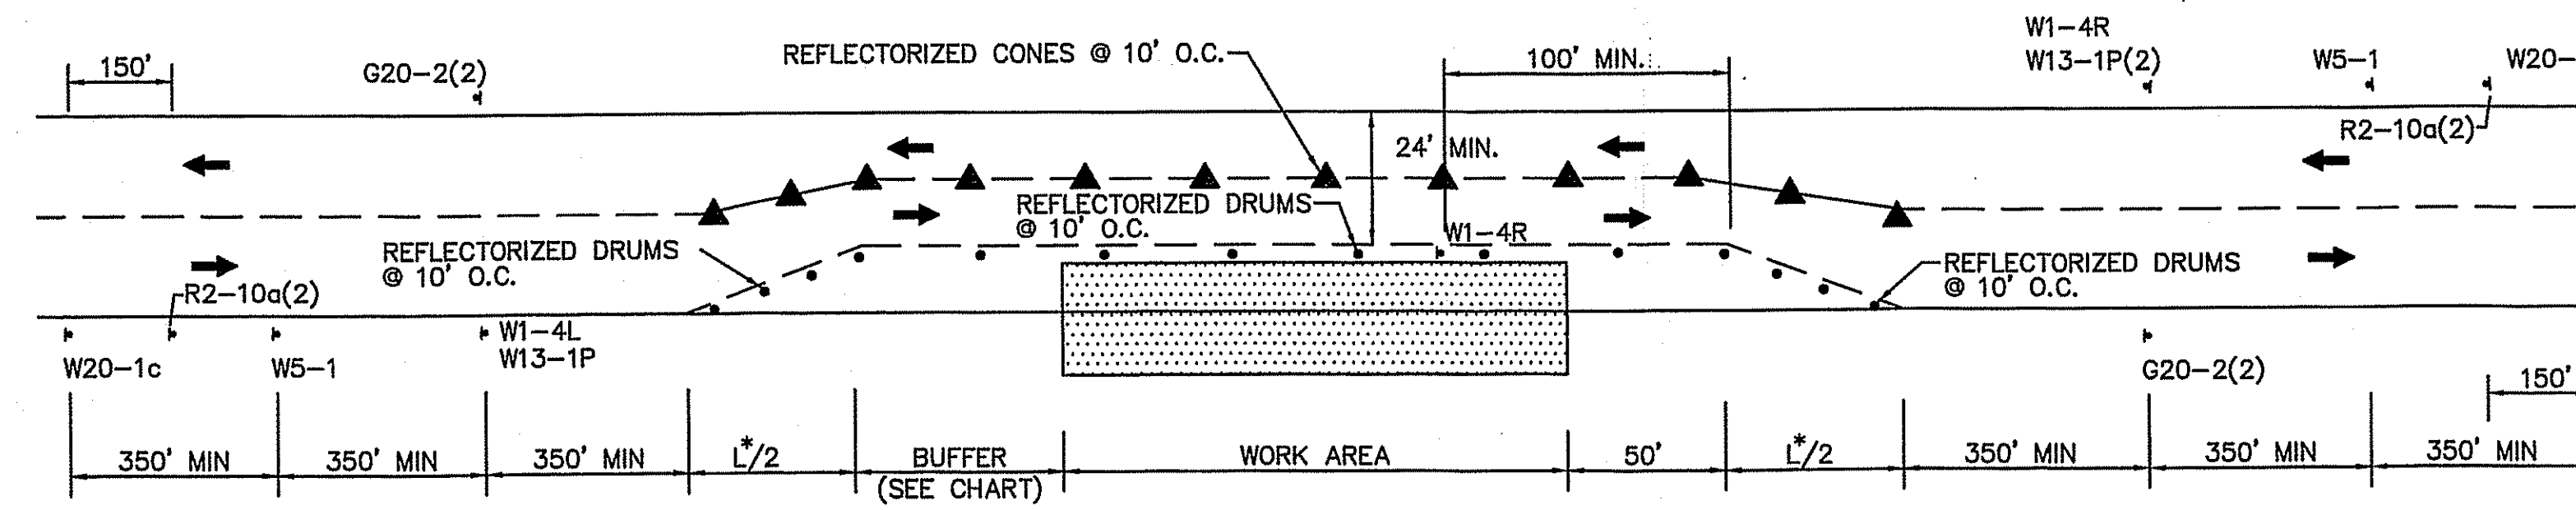

TYPICAL TWO WAY STREET LANE SHIFT


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TYPICAL TWO WAY STREET LANE CLOSURE

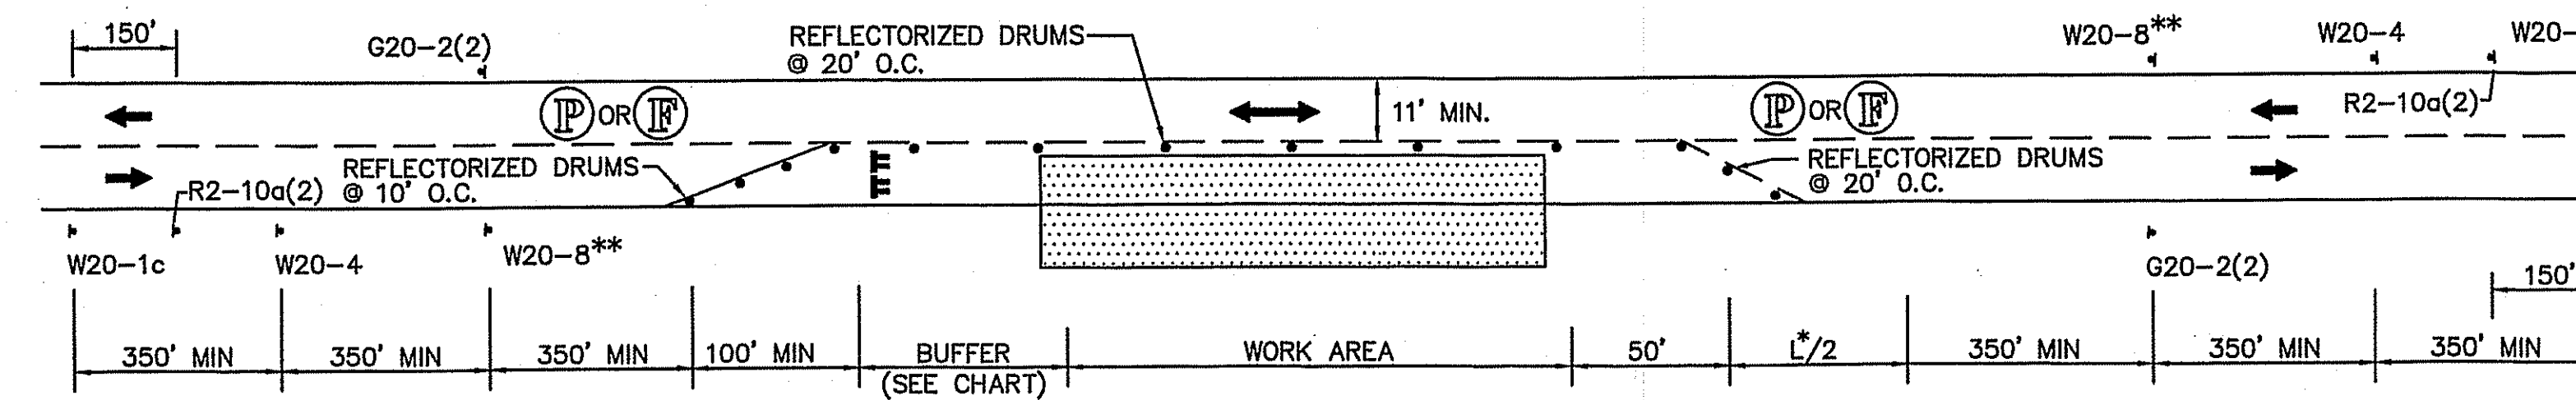
NOT TO SCALE

\*\* SEE NOTE 15



RIGHT SHOULDER CLOSURE AT  
LAKE STREET AND ROUTE 2 ON RAMP

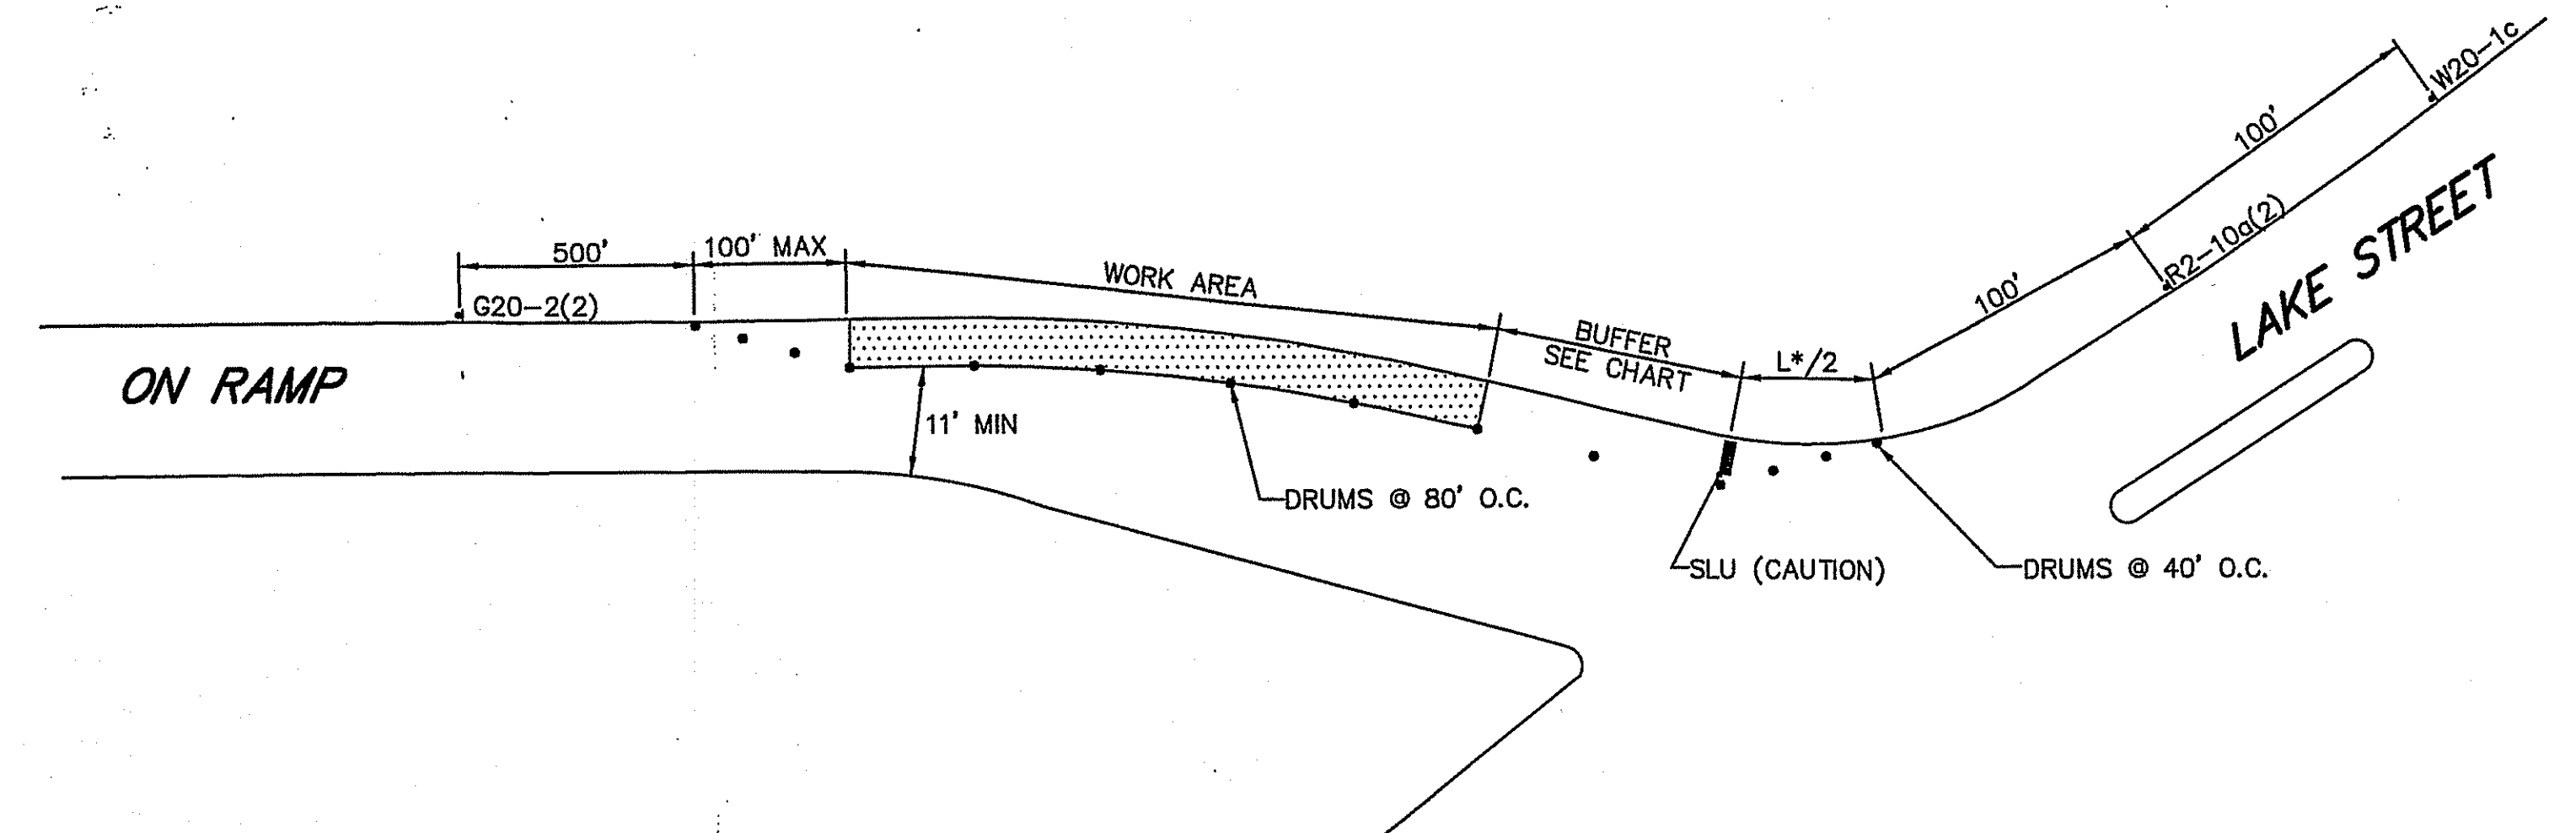SCALE: NOT TO SCALE

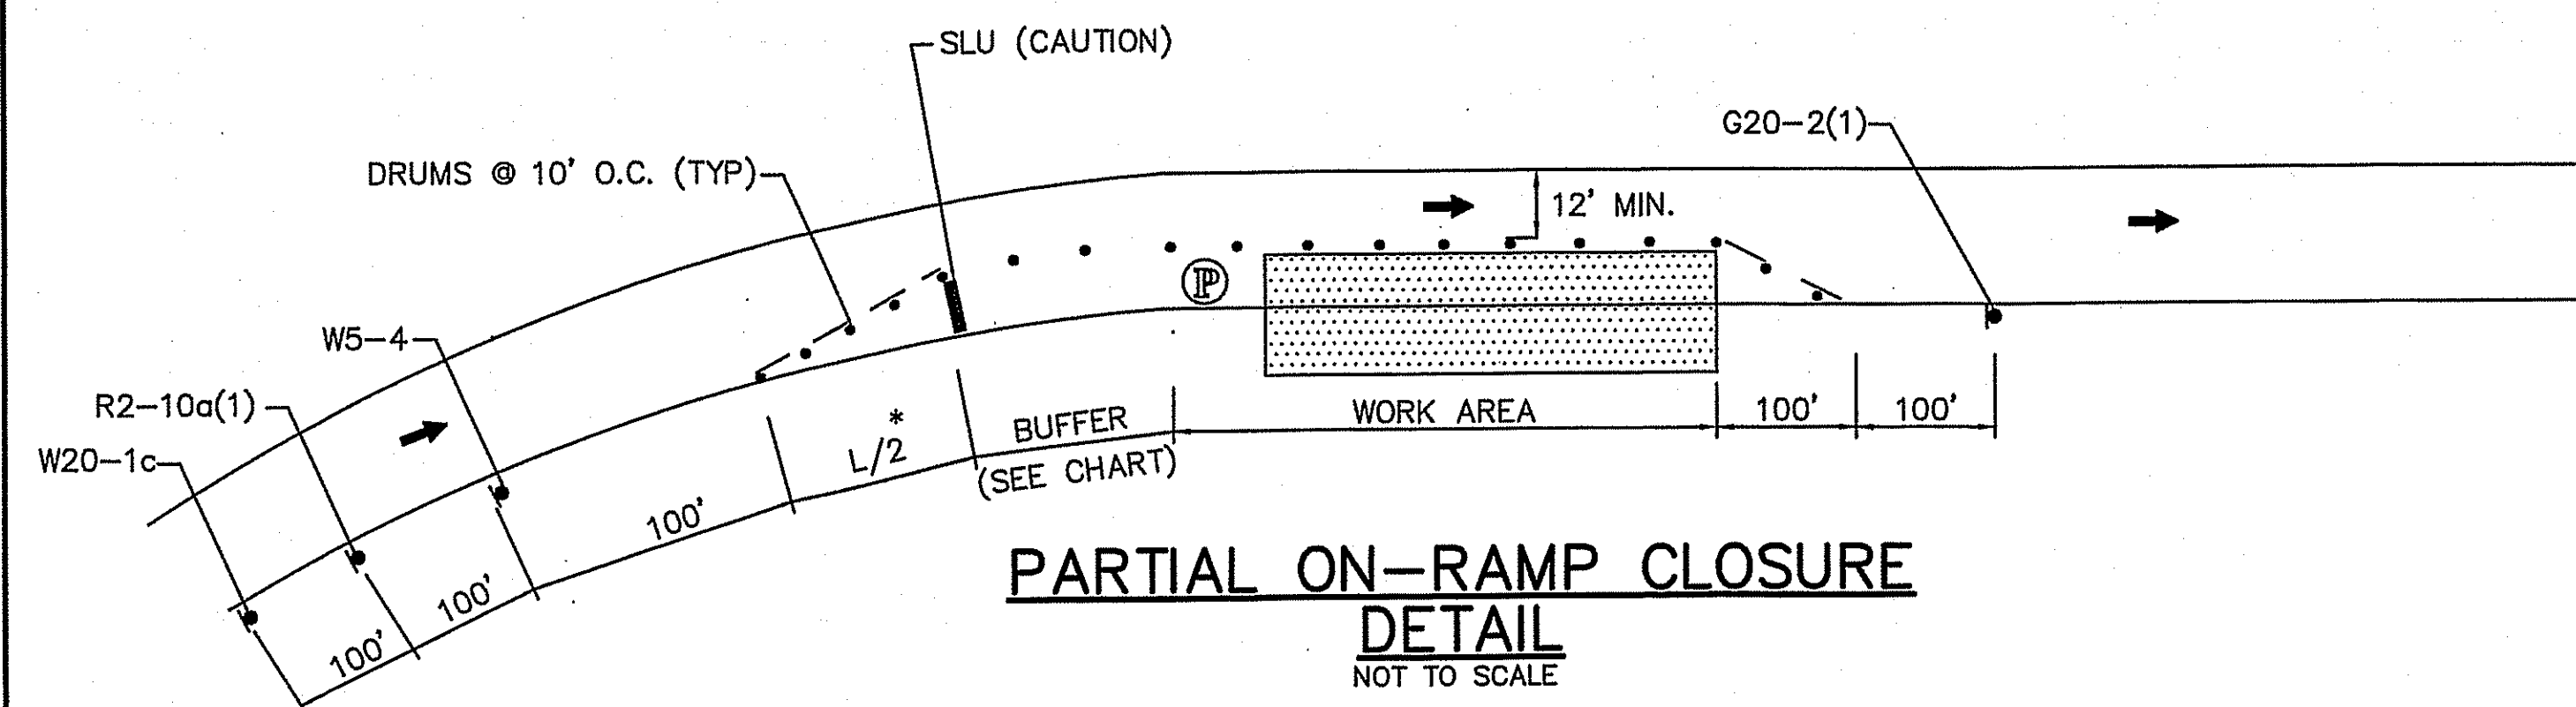


PARTIAL ON-RAMP CLOSURE  
DETAIL

NOT TO SCALE



| STATE            | FED. AID PROJ. NO. | SHEET NO. | TOTAL SHEETS |
|------------------|--------------------|-----------|--------------|
| MA               | (STP)-002S(352)    | 11        | 14           |
| PROJECT FILE NO. |                    | 606280    |              |

TEMPORARY TRAFFIC CONTROL PLANS

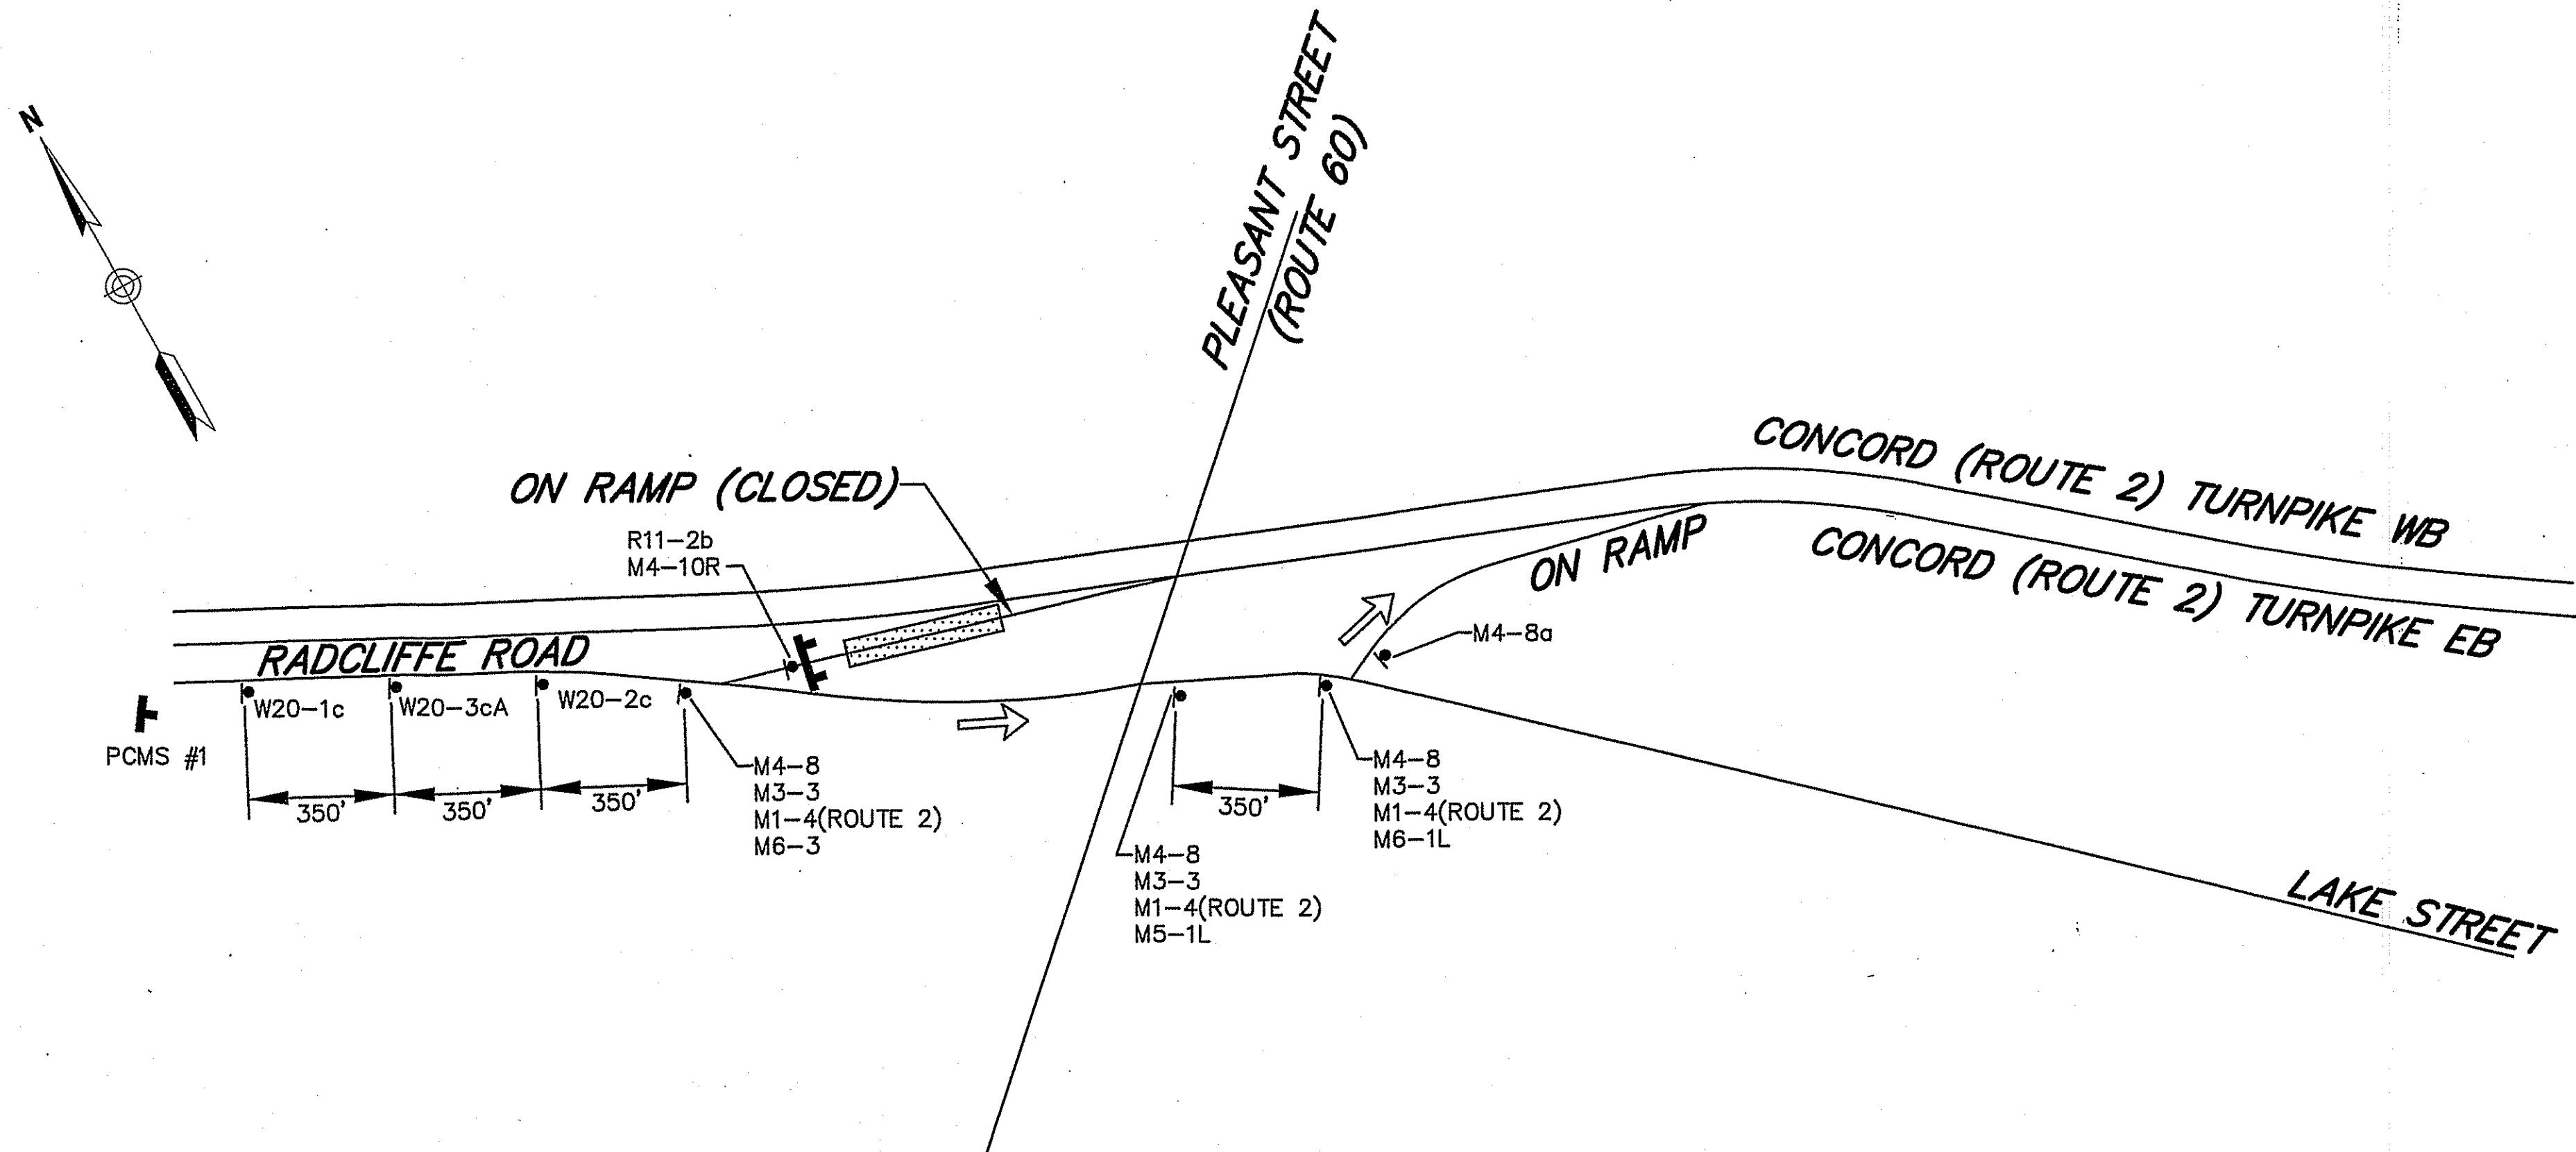


PCMS #1 TEXT

|                            |                 |
|----------------------------|-----------------|
| RTE 2<br>ON-RAMP<br>CLOSED | DETOUR<br>AHEAD |
|----------------------------|-----------------|


**CONCORD (ROUTE 2) TURNPIKE INTERCHANGE  
58 EASTBOUND ON-RAMP CLOSURE DETOUR**

SCALE: NOT TO SCALE

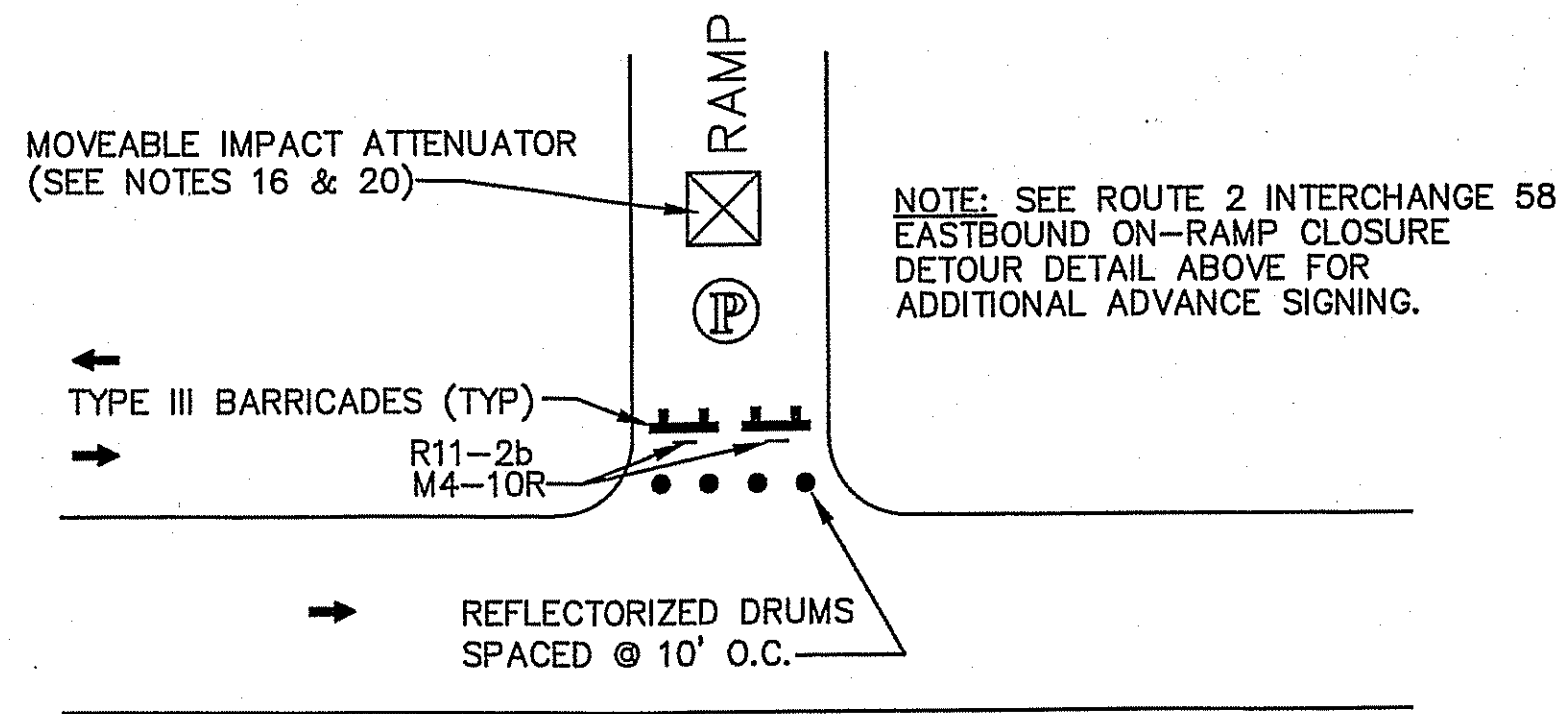

**ROUTE 2 ON-RAMP CLOSURE**




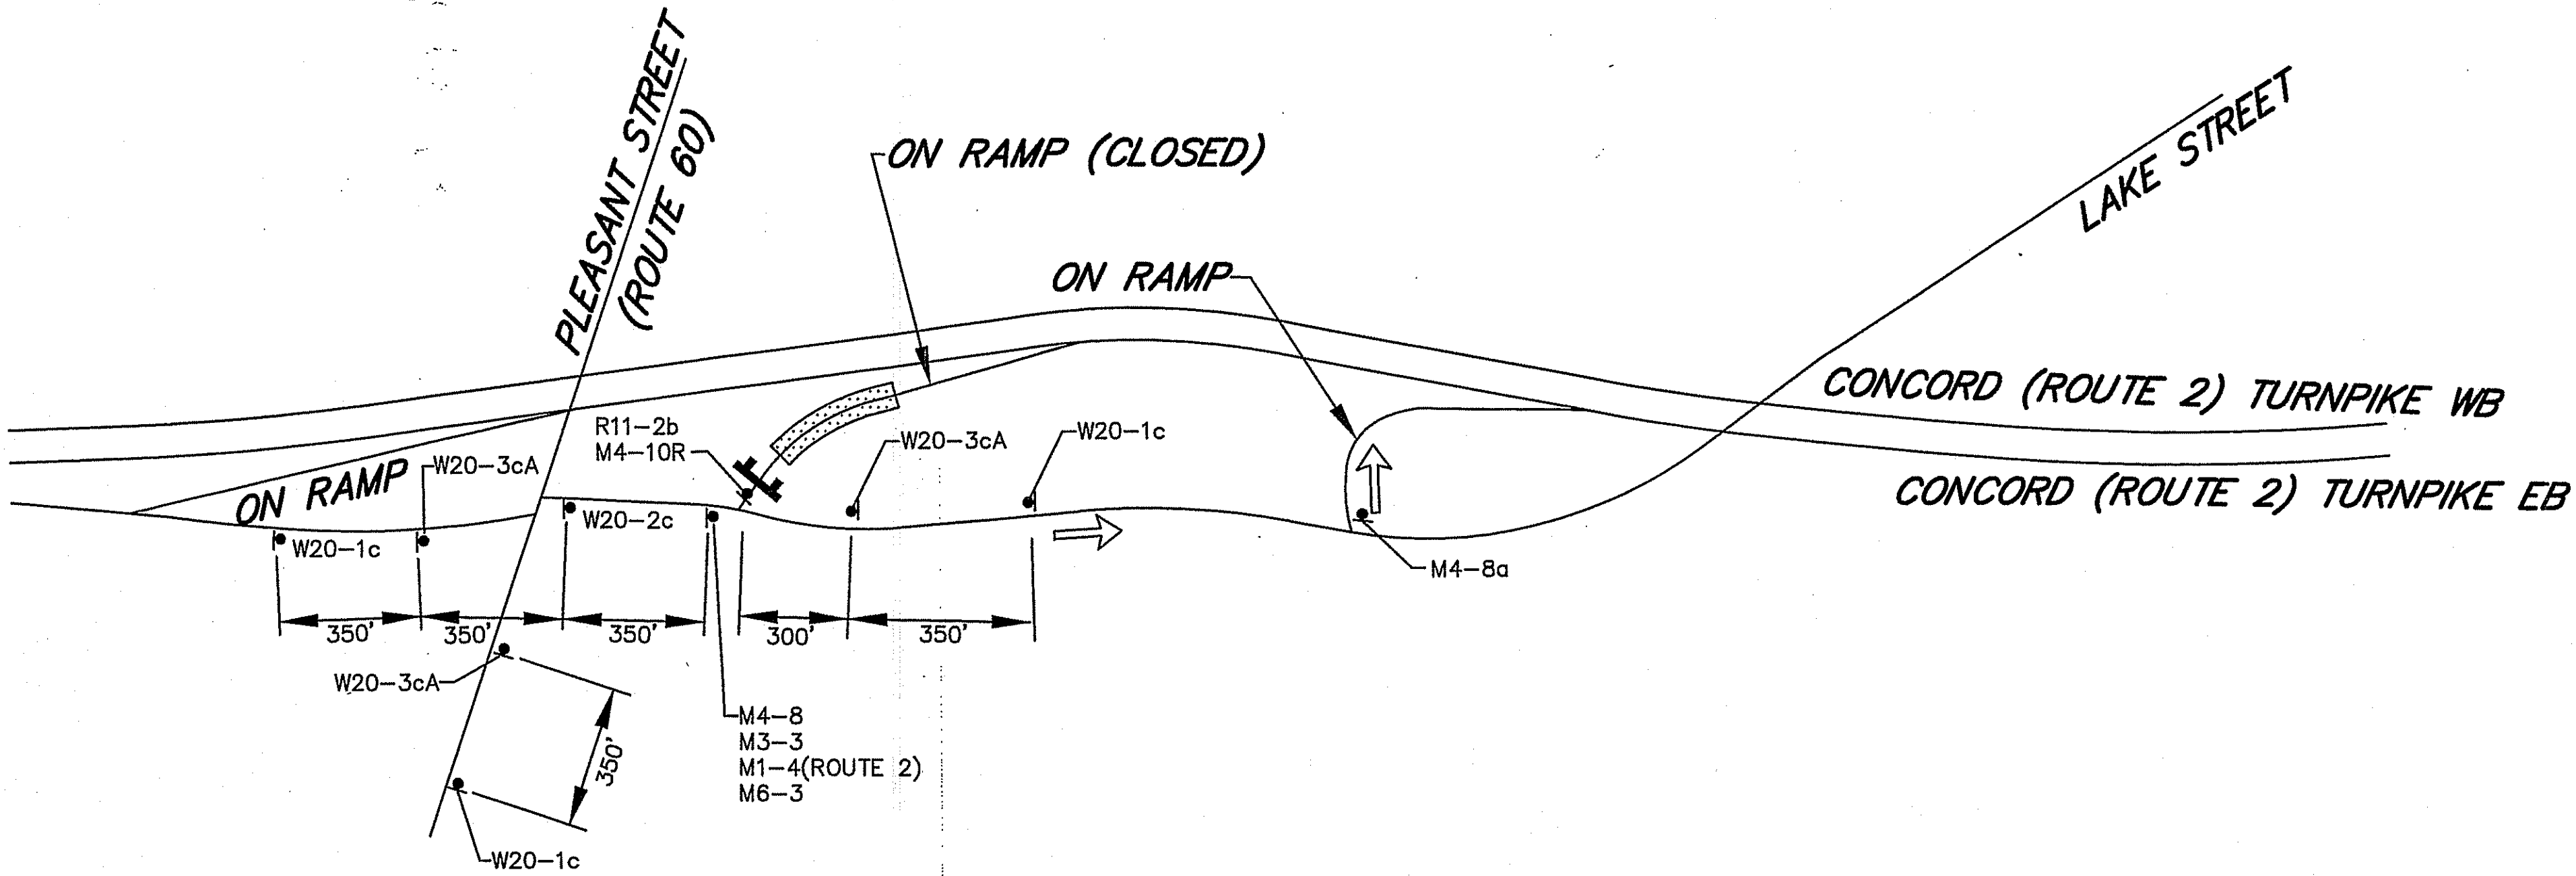

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


**CONCORD (ROUTE 2) TURNPIKE INTERCHANGE  
59 EASTBOUND ON-RAMP CLOSURE DETOUR**

SCALE: NOT TO SCALE

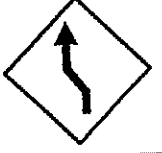TEMPORARY TRAFFIC CONTROL SIGNS


| IDENTIFI-<br>CATION<br>NUMBER | SIZE OF SIGN |            | TEXT  | COLOR           |                |        | TEXT DIMENSIONS (INCHES)   |                     |                    |
|-------------------------------|--------------|------------|---|-----------------|----------------|--------|--|---------------------|--------------------|
|                               | WIDTH        | HEIGHT     |   | BACK-<br>GROUND | LEGEND         | BORDER | LETTER<br>HEIGHT   | VERTICAL<br>SPACING | ARROW<br>RTE. MKR. |
| G20-2(1)<br>G20-2(2)          | 48"<br>36"   | 24"<br>18" | END<br>ROAD WORK  | ORANGE          | BLACK          | BLACK  | SEE MANUAL ON UNIFORM<br>TRAFFIC CONTROL DEVICES FOR<br>STREETS AND HIGHWAYS |                     |                    |
| R1-1                          | 36"          | 36"        | STOP  | RED             | RED/<br>WHITE  | WHITE  |  |                     |                    |
| R2-10a(1)<br>R2-10a(2)        | 60"<br>48"   | 48"<br>36" | WORK ZONE<br>SPEEDING<br>FINES<br>DOUBLED   | ORANGE<br>WHITE | BLACK          | BLACK  |  |                     |                    |
| R11-2b                        | 48"          | 30"        | RAMP<br>CLOSED  | WHITE           | BLACK          | BLACK  |  |                     |                    |
| W1-4L                         | 30"          | 30"        |    | ORANGE          | BLACK          | BLACK  |  |                     |                    |
| W1-4R                         | 30"          | 30"        |    | ORANGE          | BLACK          | BLACK  |  |                     |                    |
| W3-1                          | 36"          | 36"        |   | ORANGE<br>RED   | BLACK<br>WHITE | BLACK  |  |                     |                    |
| W4-1R                         | 48"          | 48"        |  | ORANGE          | BLACK          | BLACK  |  |                     |                    |
| W4-2R                         | 48"          | 48"        |  | ORANGE          | BLACK          | BLACK  |  |                     |                    |
| W5-1                          | 36"          | 36"        | ROAD<br>NARROWS   | ORANGE          | BLACK          | BLACK  |  |                     |                    |
| W5-4                          | 36"          | 36"        | RAMP<br>NARROWS   | ORANGE          | BLACK          | BLACK  |  |                     |                    |
| W13-1P                        | 36"          | 48"        | XX<br>MPH   | ORANGE          | BLACK          | BLACK  |  |                     |                    |
| W20-1a                        | 48"          | 48"        | ROAD<br>WORK<br>1 MILE  | ORANGE          | BLACK          | BLACK  |  |                     |                    |
| W20-1b                        | 48"          | 48"        | ROAD<br>WORK<br>1/2 MILE  | ORANGE          | BLACK          | BLACK  |  |                     |                    |
| W20-1c                        | 36"          | 36"        | ROAD<br>WORK<br>AHEAD   | ORANGE          | BLACK          | BLACK  |  |                     |                    |
| W20-2c                        | 36"          | 36"        | DETOUR<br>AHEAD   | ORANGE          | BLACK          | BLACK  |  |                     |                    |
| W20-3cA                       | 36"          | 36"        | RAMP<br>CLOSED<br>AHEAD   | ORANGE          | BLACK          | BLACK  |  |                     | ↓                  |

| IDENTIFI-<br>CATION<br>NUMBER | SIZE OF SIGN |        | TEXT  | COLOR           |        |        | TEXT DIMENSIONS (INCHES)   |                     |                    |
|-------------------------------|--------------|--------|---|-----------------|--------|--------|--|---------------------|--------------------|
|                               | WIDTH        | HEIGHT |   | BACK-<br>GROUND | LEGEND | BORDER | LETTER<br>HEIGHT   | VERTICAL<br>SPACING | ARROW<br>RTE. MKR. |
| W20-4                         | 36"          | 36"    | ONE LANE<br>ROAD  | ORANGE          | BLACK  | BLACK  | SEE MANUAL ON UNIFORM<br>TRAFFIC CONTROL DEVICES FOR<br>STREETS AND HIGHWAYS |                     |                    |
| W20-5b(R)                     | 48"          | 48"    | RIGHT LANE<br>CLOSED<br>1/2 MILE  | ORANGE          | BLACK  | BLACK  |  |                     |                    |
| W20-7a                        | 36"          | 36"    |  | ORANGE          | BLACK  | BLACK  |  |                     |                    |
| W20-8                         | 36"          | 36"    | POLICE<br>OFFICER<br>AHEAD  | ORANGE          | BLACK  | BLACK  |  |                     |                    |
| W21-5aR                       | 36"          | 36"    | RIGHT<br>SHOULDER<br>CLOSED   | ORANGE          | BLACK  | BLACK  |  |                     |                    |
| M1-4(2)                       | 36"          | 36"    | 2   | WHITE           | BLACK  | BLACK  |  |                     |                    |
| M3-3                          | 24"          | 12"    | EAST  | WHITE           | BLACK  | BLACK  |  |                     |                    |
| M4-8a                         | 24"          | 18"    | END<br>DETOUR   | ORANGE          | BLACK  | BLACK  |  |                     |                    |
| M4-8                          | 24"          | 12"    | DETOUR  | ORANGE          | BLACK  | BLACK  |  |                     |                    |
| M4-10R                        | 48"          | 12"    | DETOUR →  | ORANGE          | BLACK  | —      |  |                     |                    |
| M5-1L                         | 30"          | 21"    | ↙   | ORANGE          | BLACK  | BLACK  |  |                     |                    |
| M6-1L                         | 30"          | 21"    | ←   | ORANGE          | BLACK  | BLACK  |  |                     |                    |
| M6-3                          | 30"          | 21"    | ↑   | ORANGE          | BLACK  | BLACK  |  |                     | ↓                  |



| STATE            | FED. AID PROJ. NO. | SHEET NO. | TOTAL SHEETS |
|------------------|--------------------|-----------|--------------|
| MA               | (STP)-002S(352)    | 13        | 14           |
| PROJECT FILE NO. |                    | 606280    |              |

CONSTRUCTION DETAILS

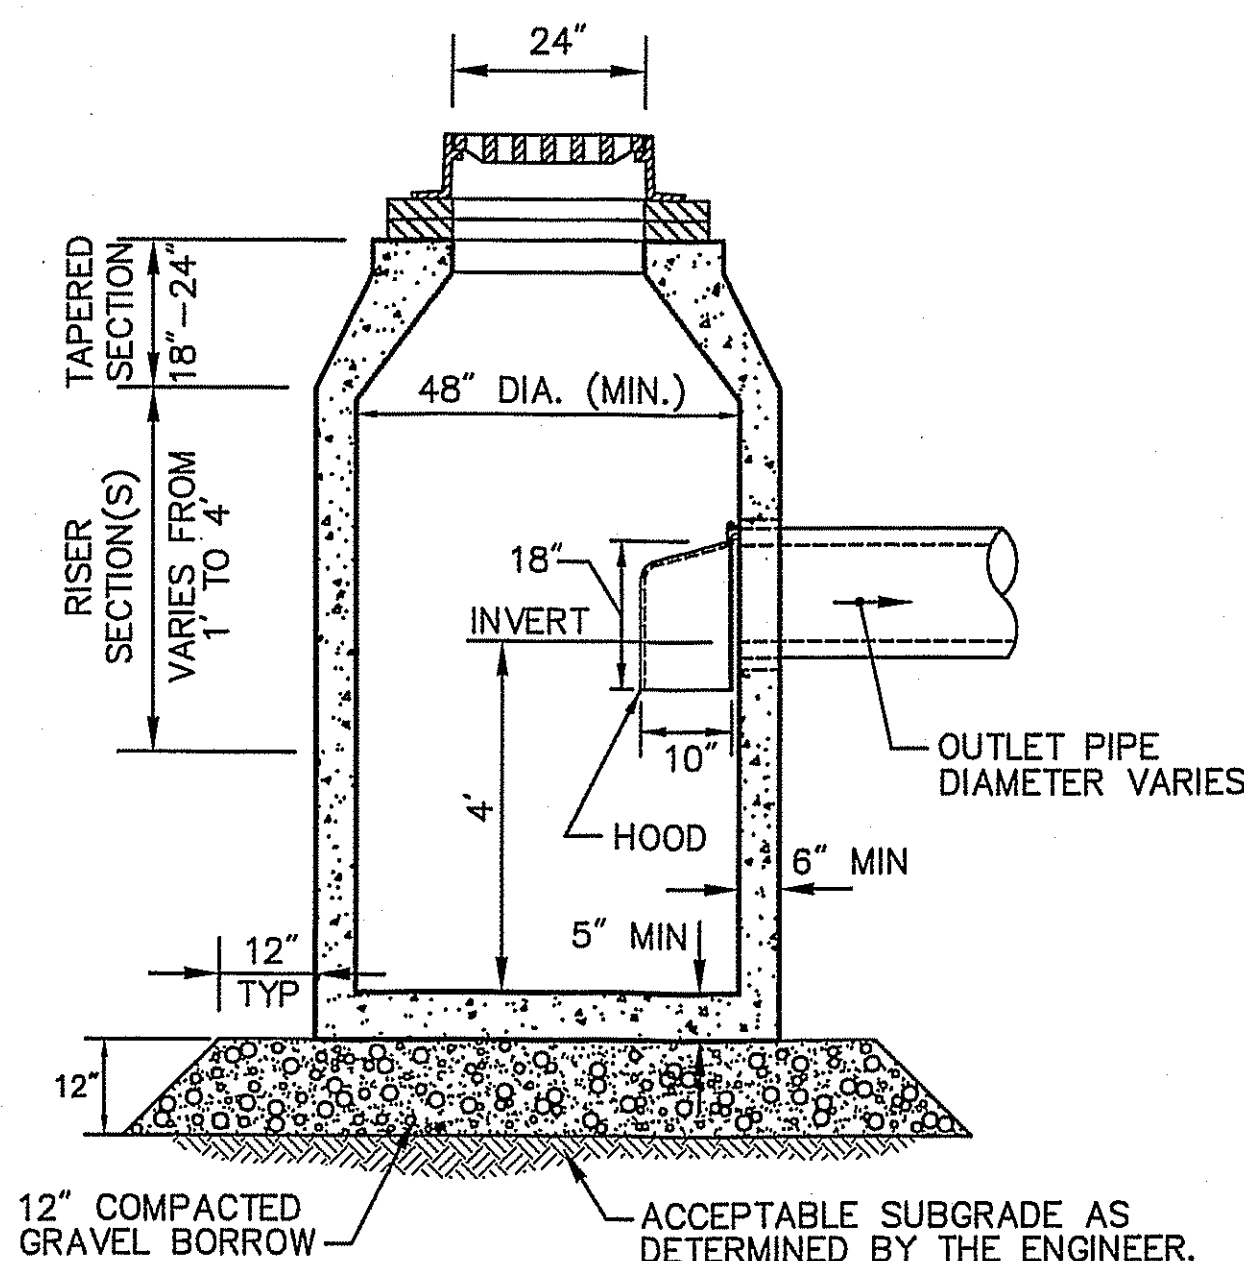


NOTES:

1. TOP SLAB OPENINGS FOR CBCI SHALL BE 24"x 27".
2. 6" MINIMUM SPACE FROM TOP OF KNOCKOUT TO BOTTOM OF ROOF SLAB JOINT REQUIRED WHEN USING HOODS.


DEEP SUMP CATCH BASIN WITH HOOD

SCALE: NOT TO SCALE  
DATE: DEC 2011  
DWG: LD-105

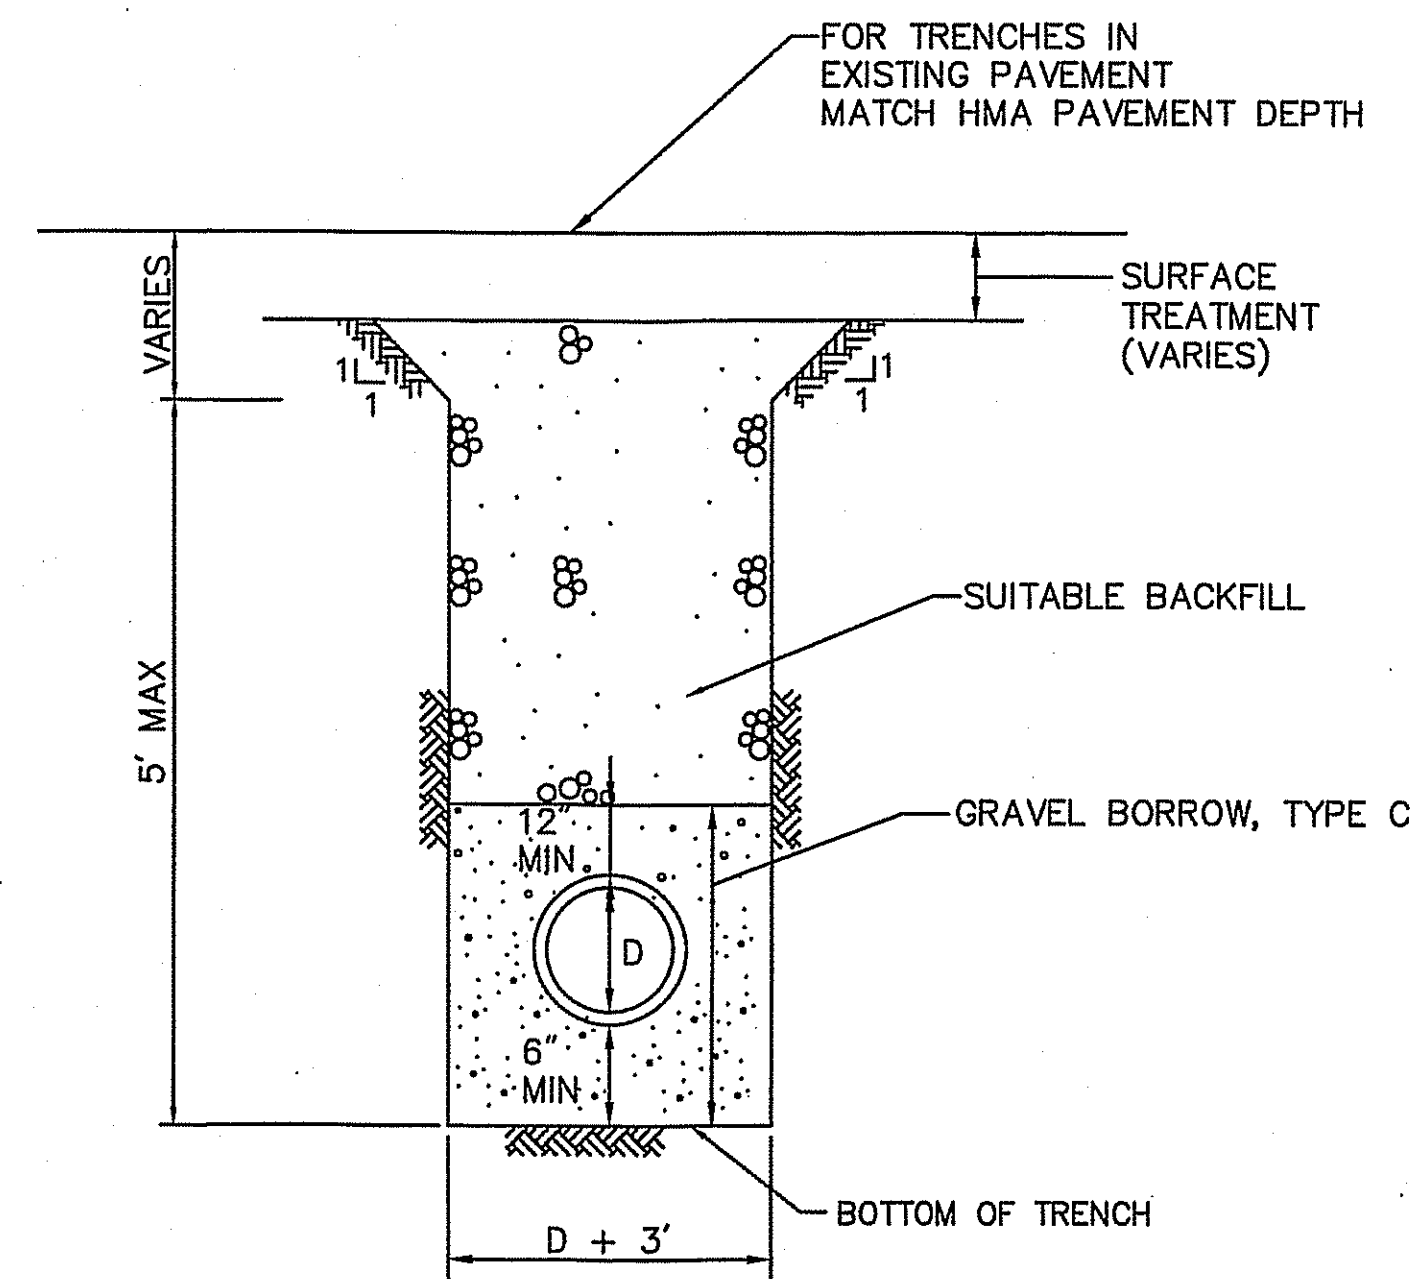


TRENCH DETAIL

SCALE: NOT TO SCALE  
DATE: -  
DWG: TRENCH-05

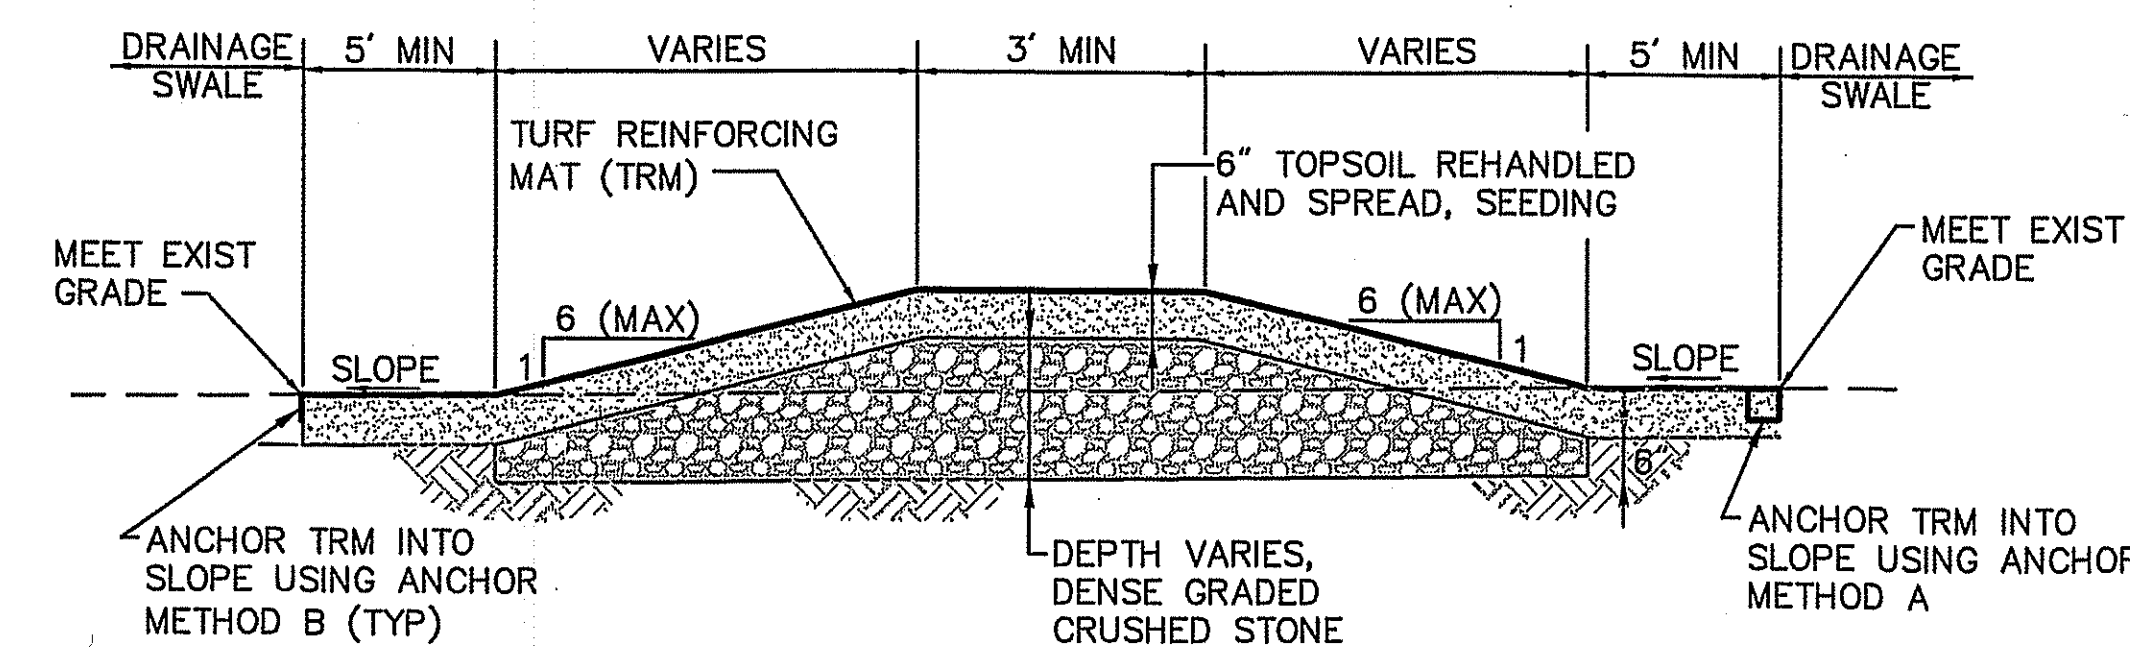


SECTION A-A

N.T.S.

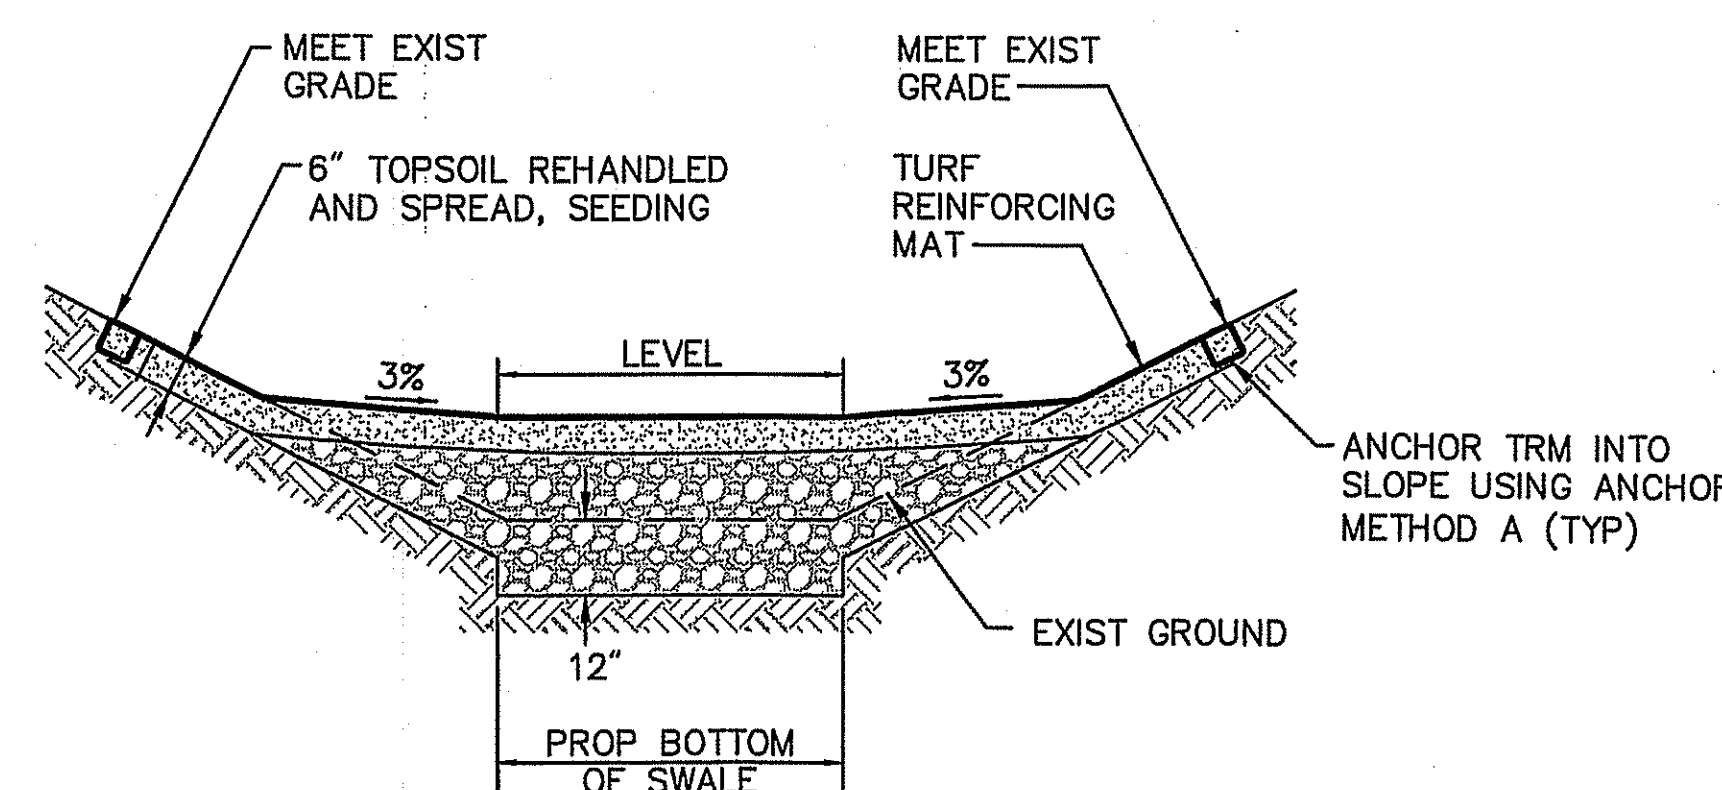


SECTION B-B

N.T.S.

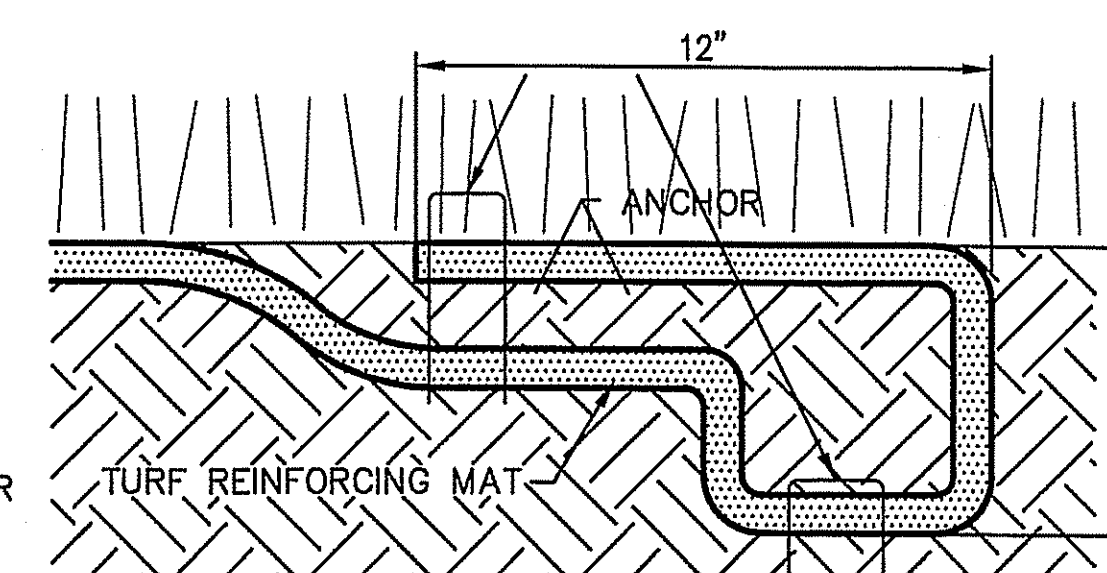


ANCHOR METHOD A

N.T.S.

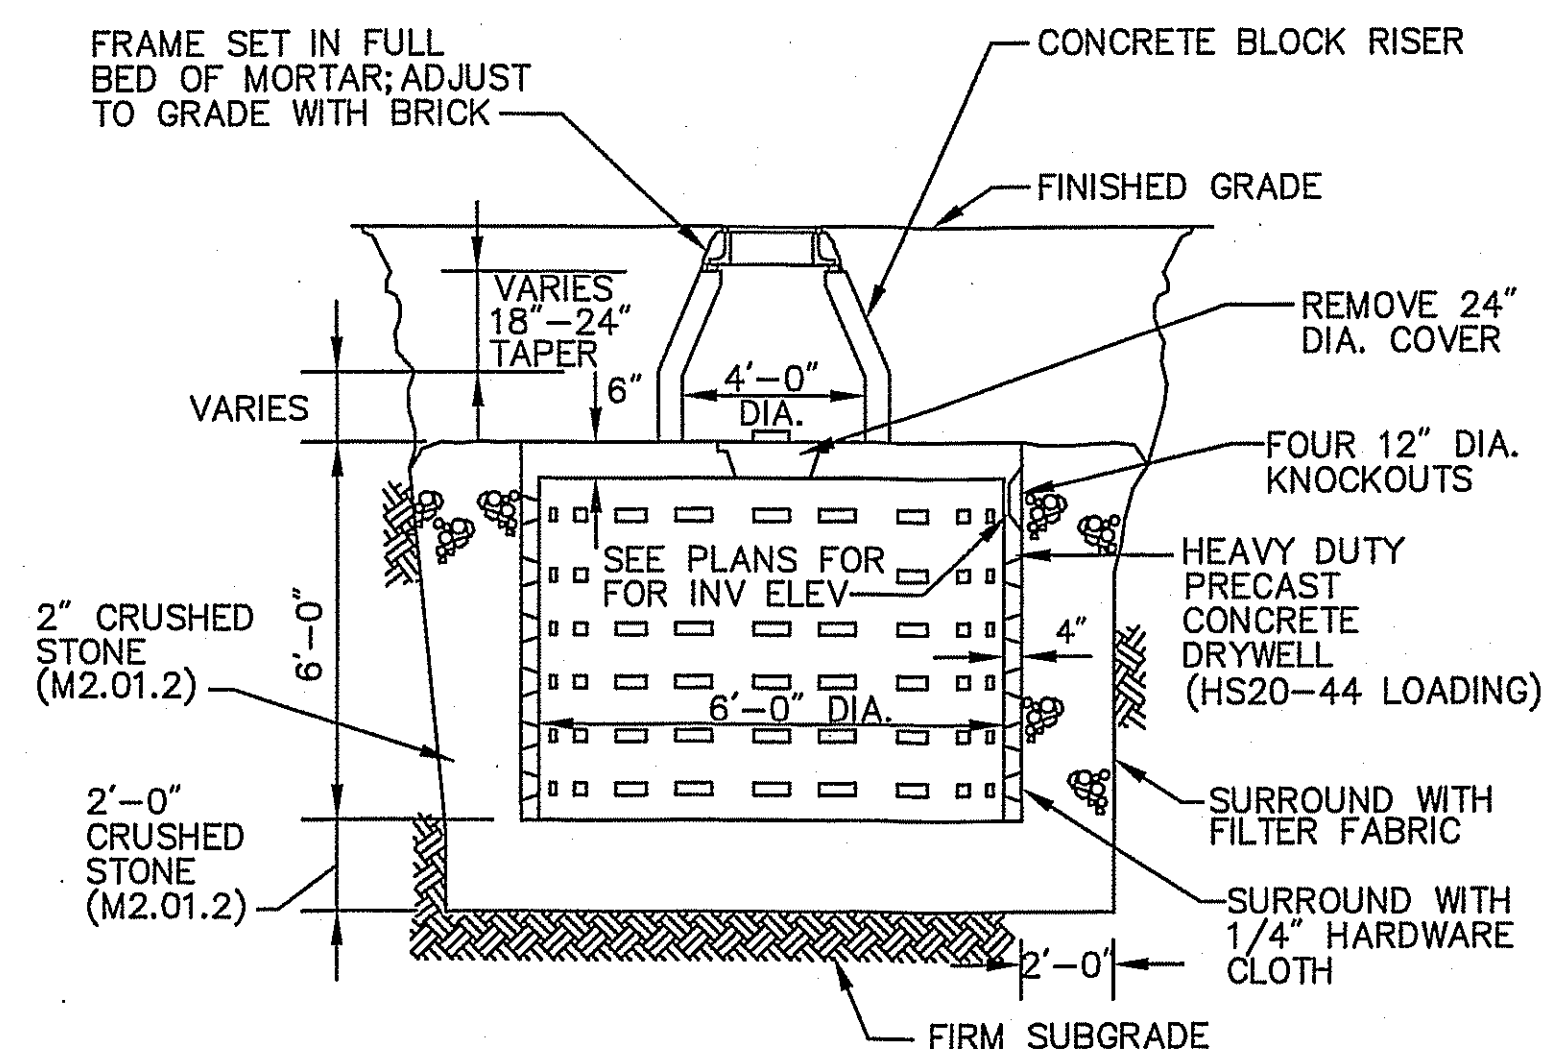


6' LEACHING BASIN

SCALE: NOT TO SCALE  
DATE: 10-28-2008  
DWG: H-STD, H92

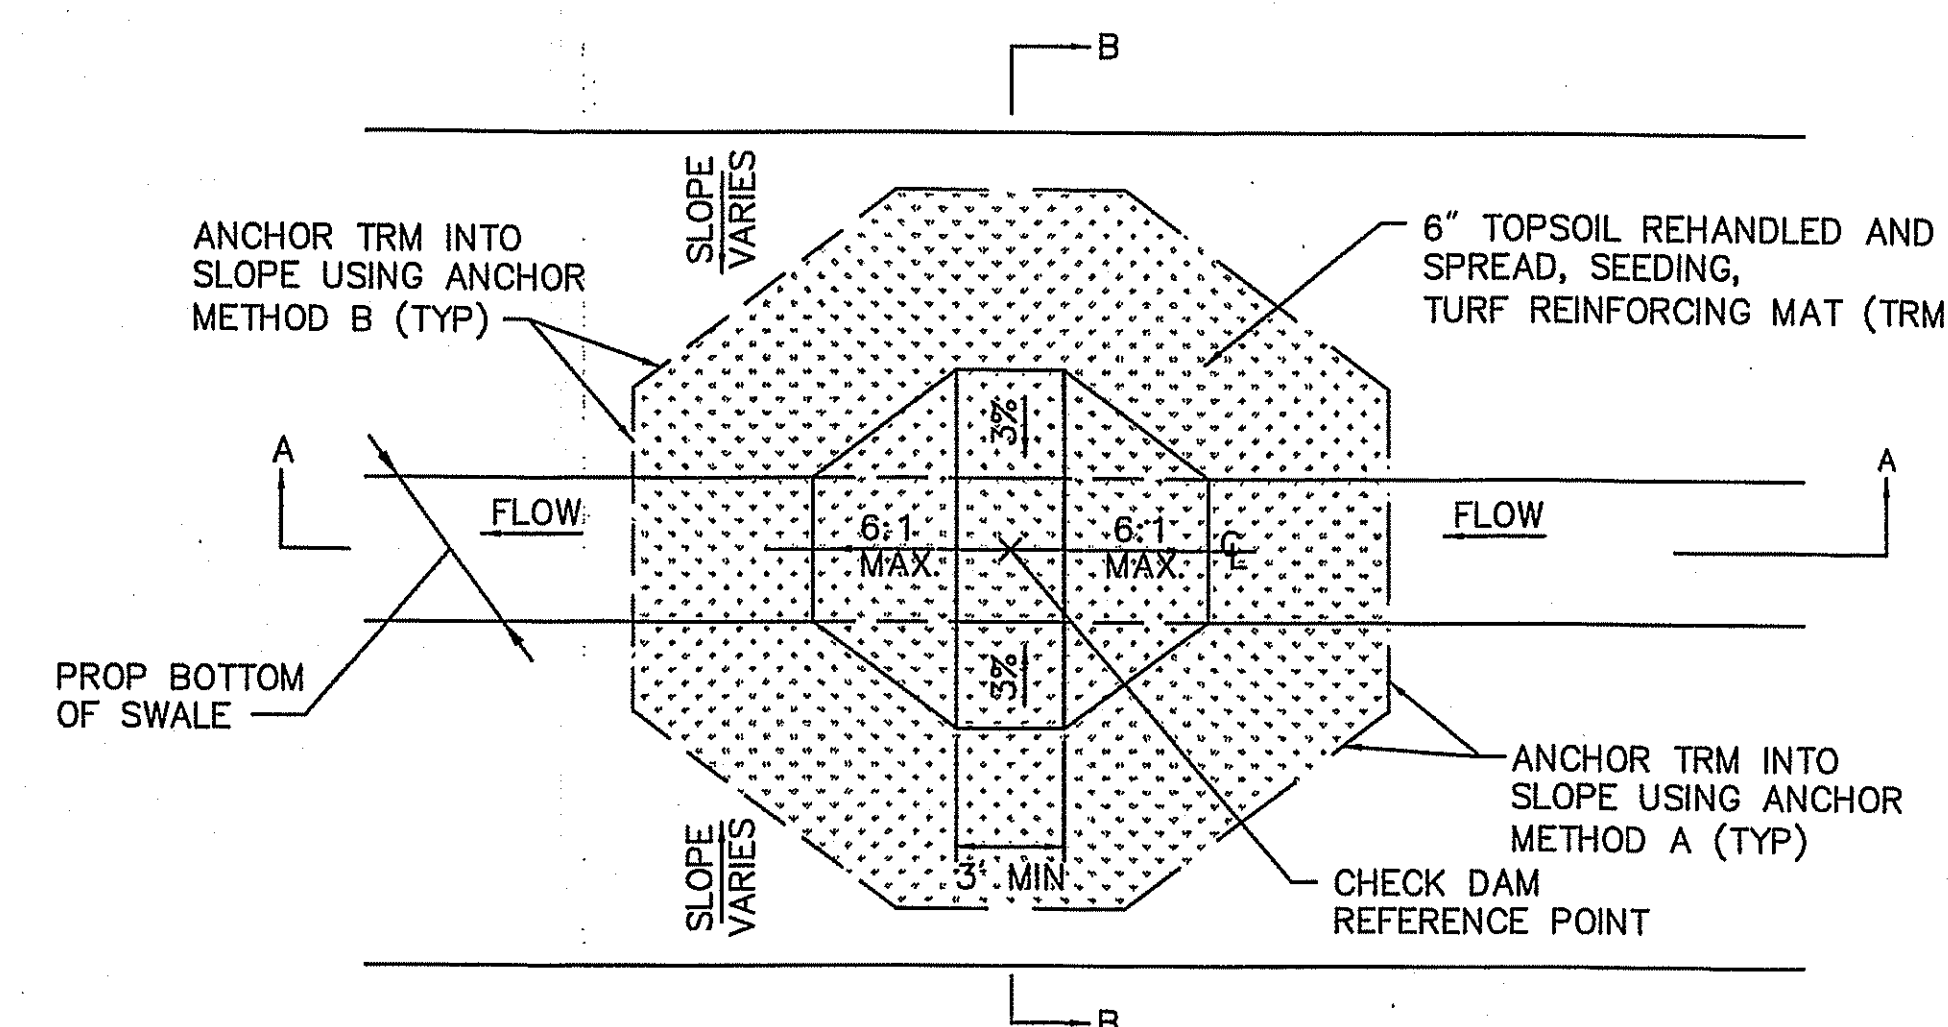

PLAN VIEW

N.T.S.

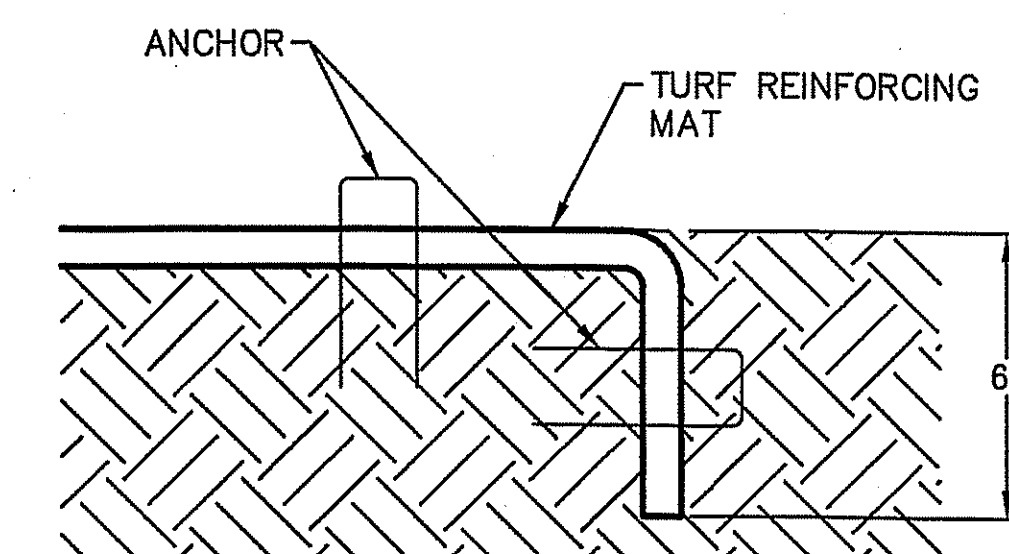


ANCHOR METHOD B

N.T.S.


CHECK DAM

SCALE: NOT TO SCALE  
DATE: DEC 2011  
DWG: N/A

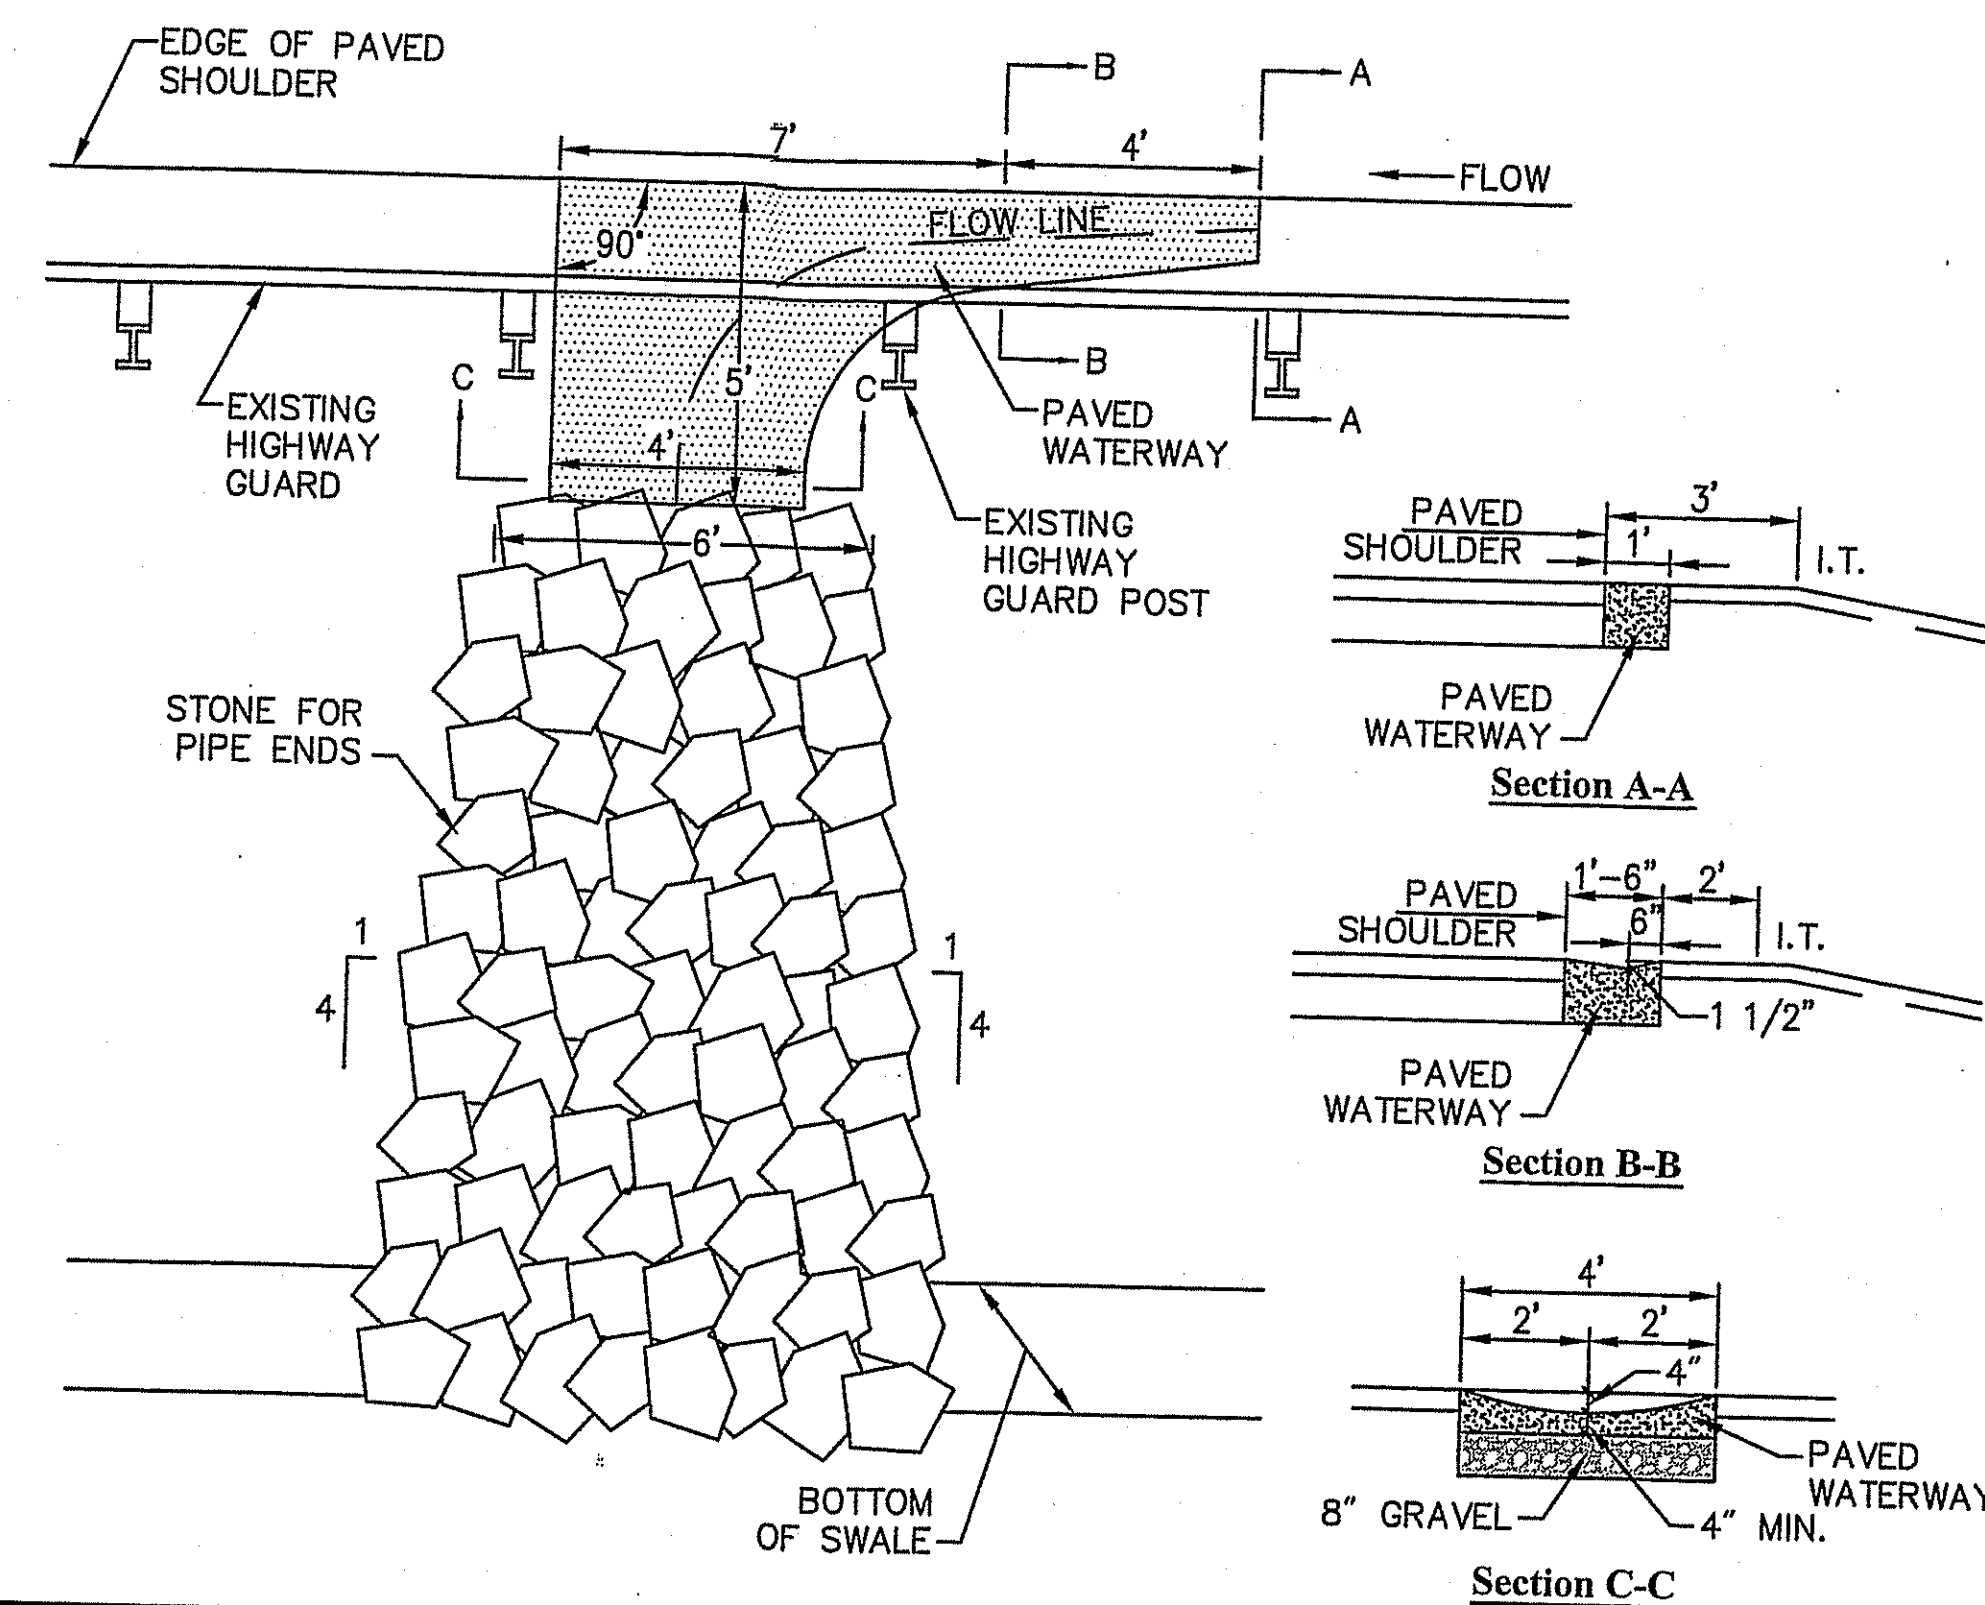

### HOT MIX ASPHALT WATERWAY

SCALE: NOT TO SCALE  
DATE: 12-23-2011  
DWG: LD-105

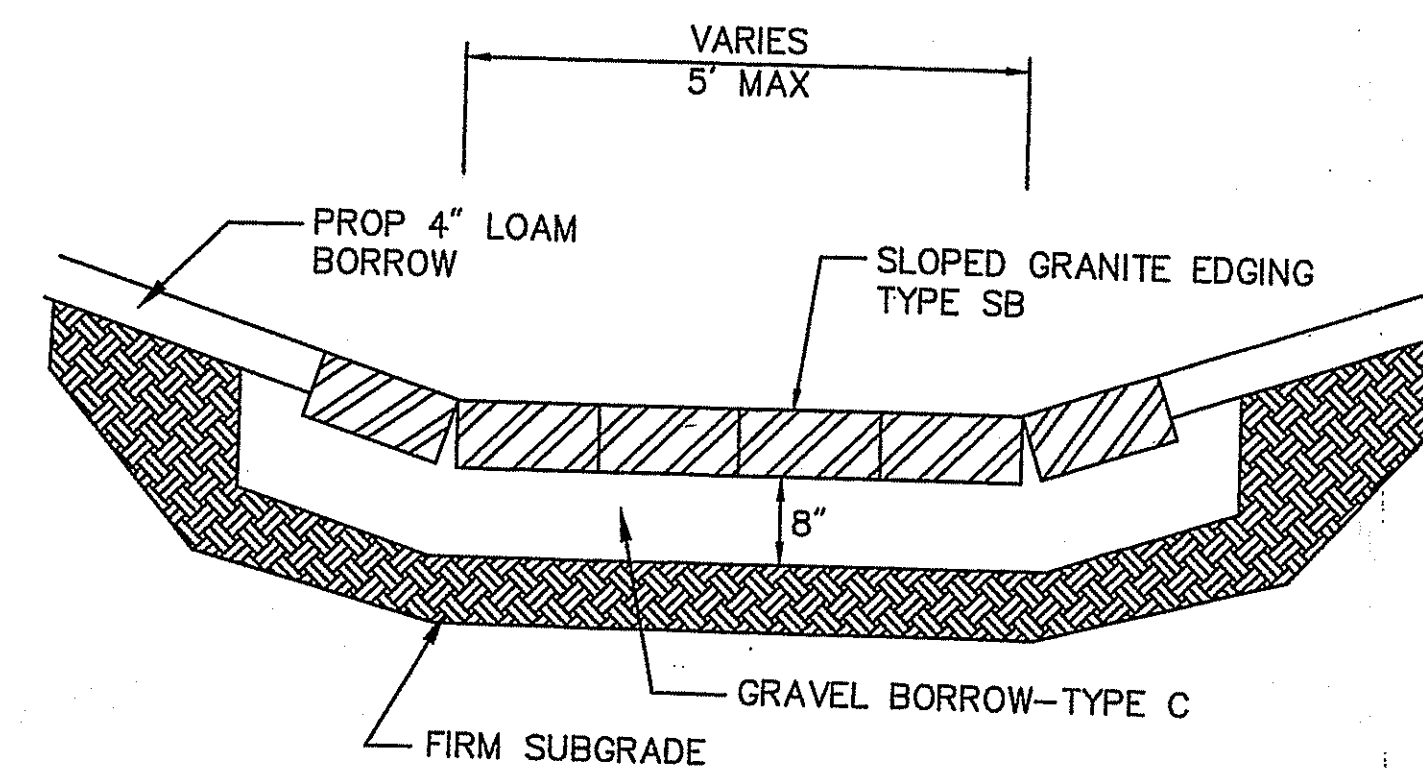


#### NOTES:

1. GRANITE EDGING WILL BE SUPPLIED BY MASSDOT DISTRICT 4. THE CONTRACTOR SHALL BE RESPONSIBLE FOR TRANSPORTING AND INSTALLATION. THE CONTRACTOR SHALL COORDINATE PICK UP TIME AND LOCATION WITH MASSDOT.


### GRANITE EDGING FOREBAY BASE

SCALE: NOT TO SCALE  
12/11

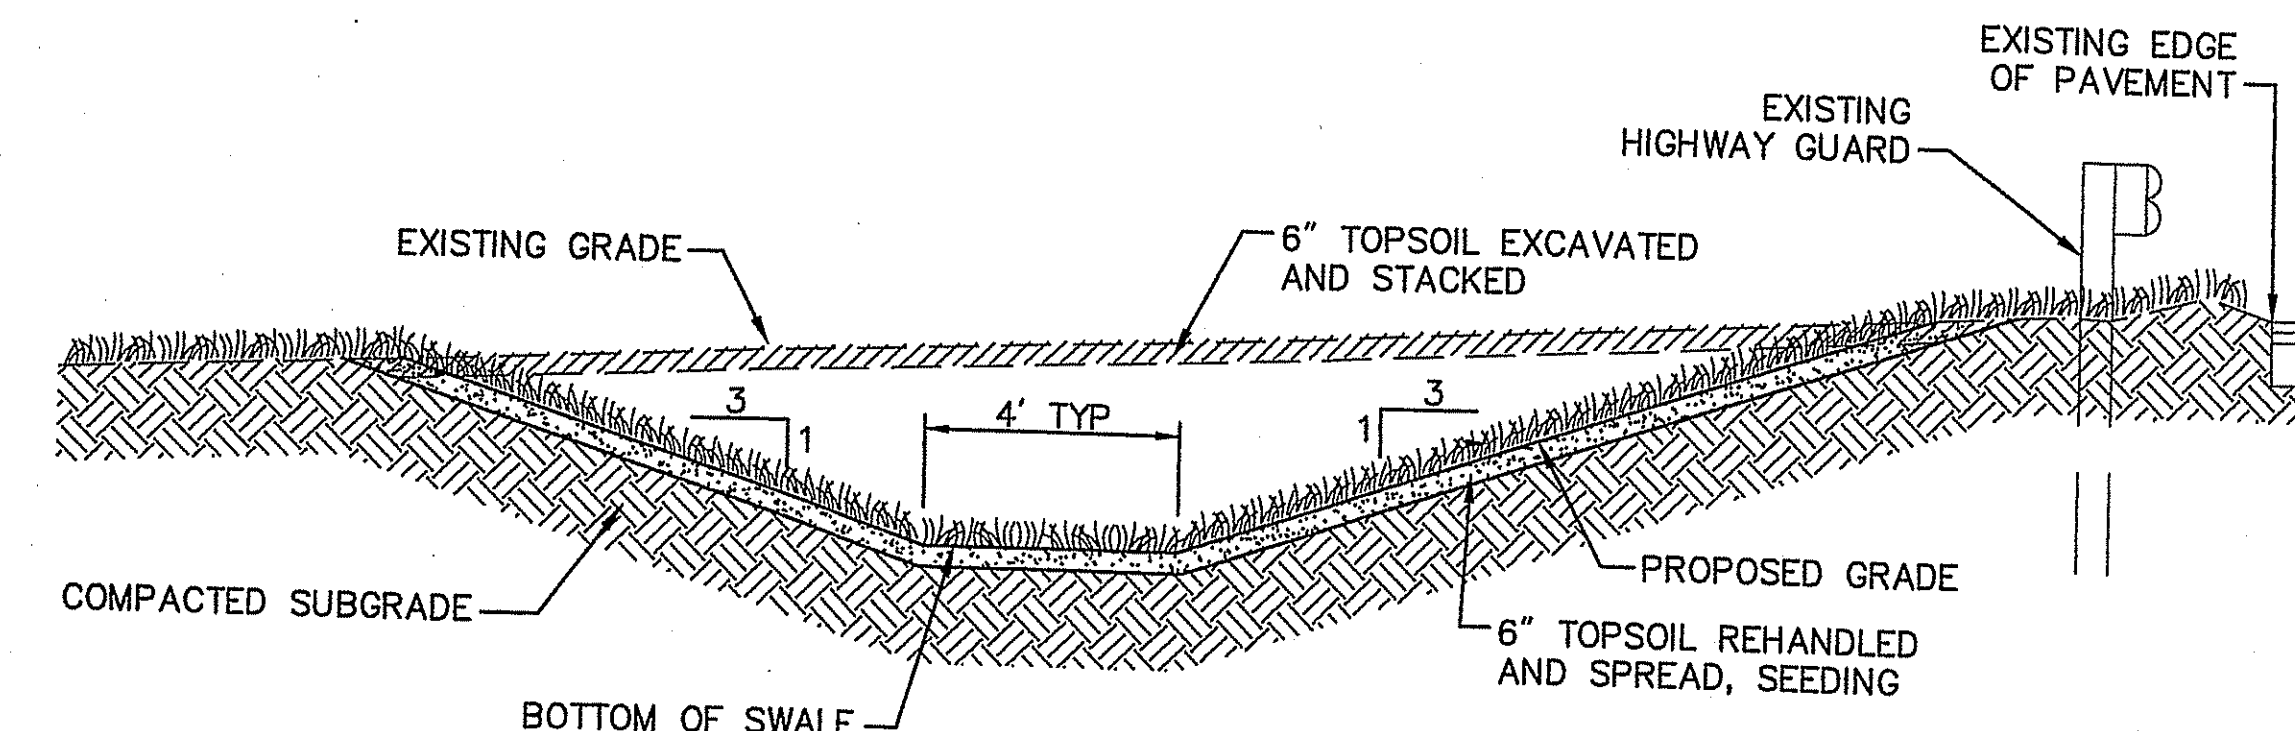


### TYPICAL SWALE SECTION

SCALE: NOT TO SCALE  
DATE: 6-22-2012  
DWG: N/A

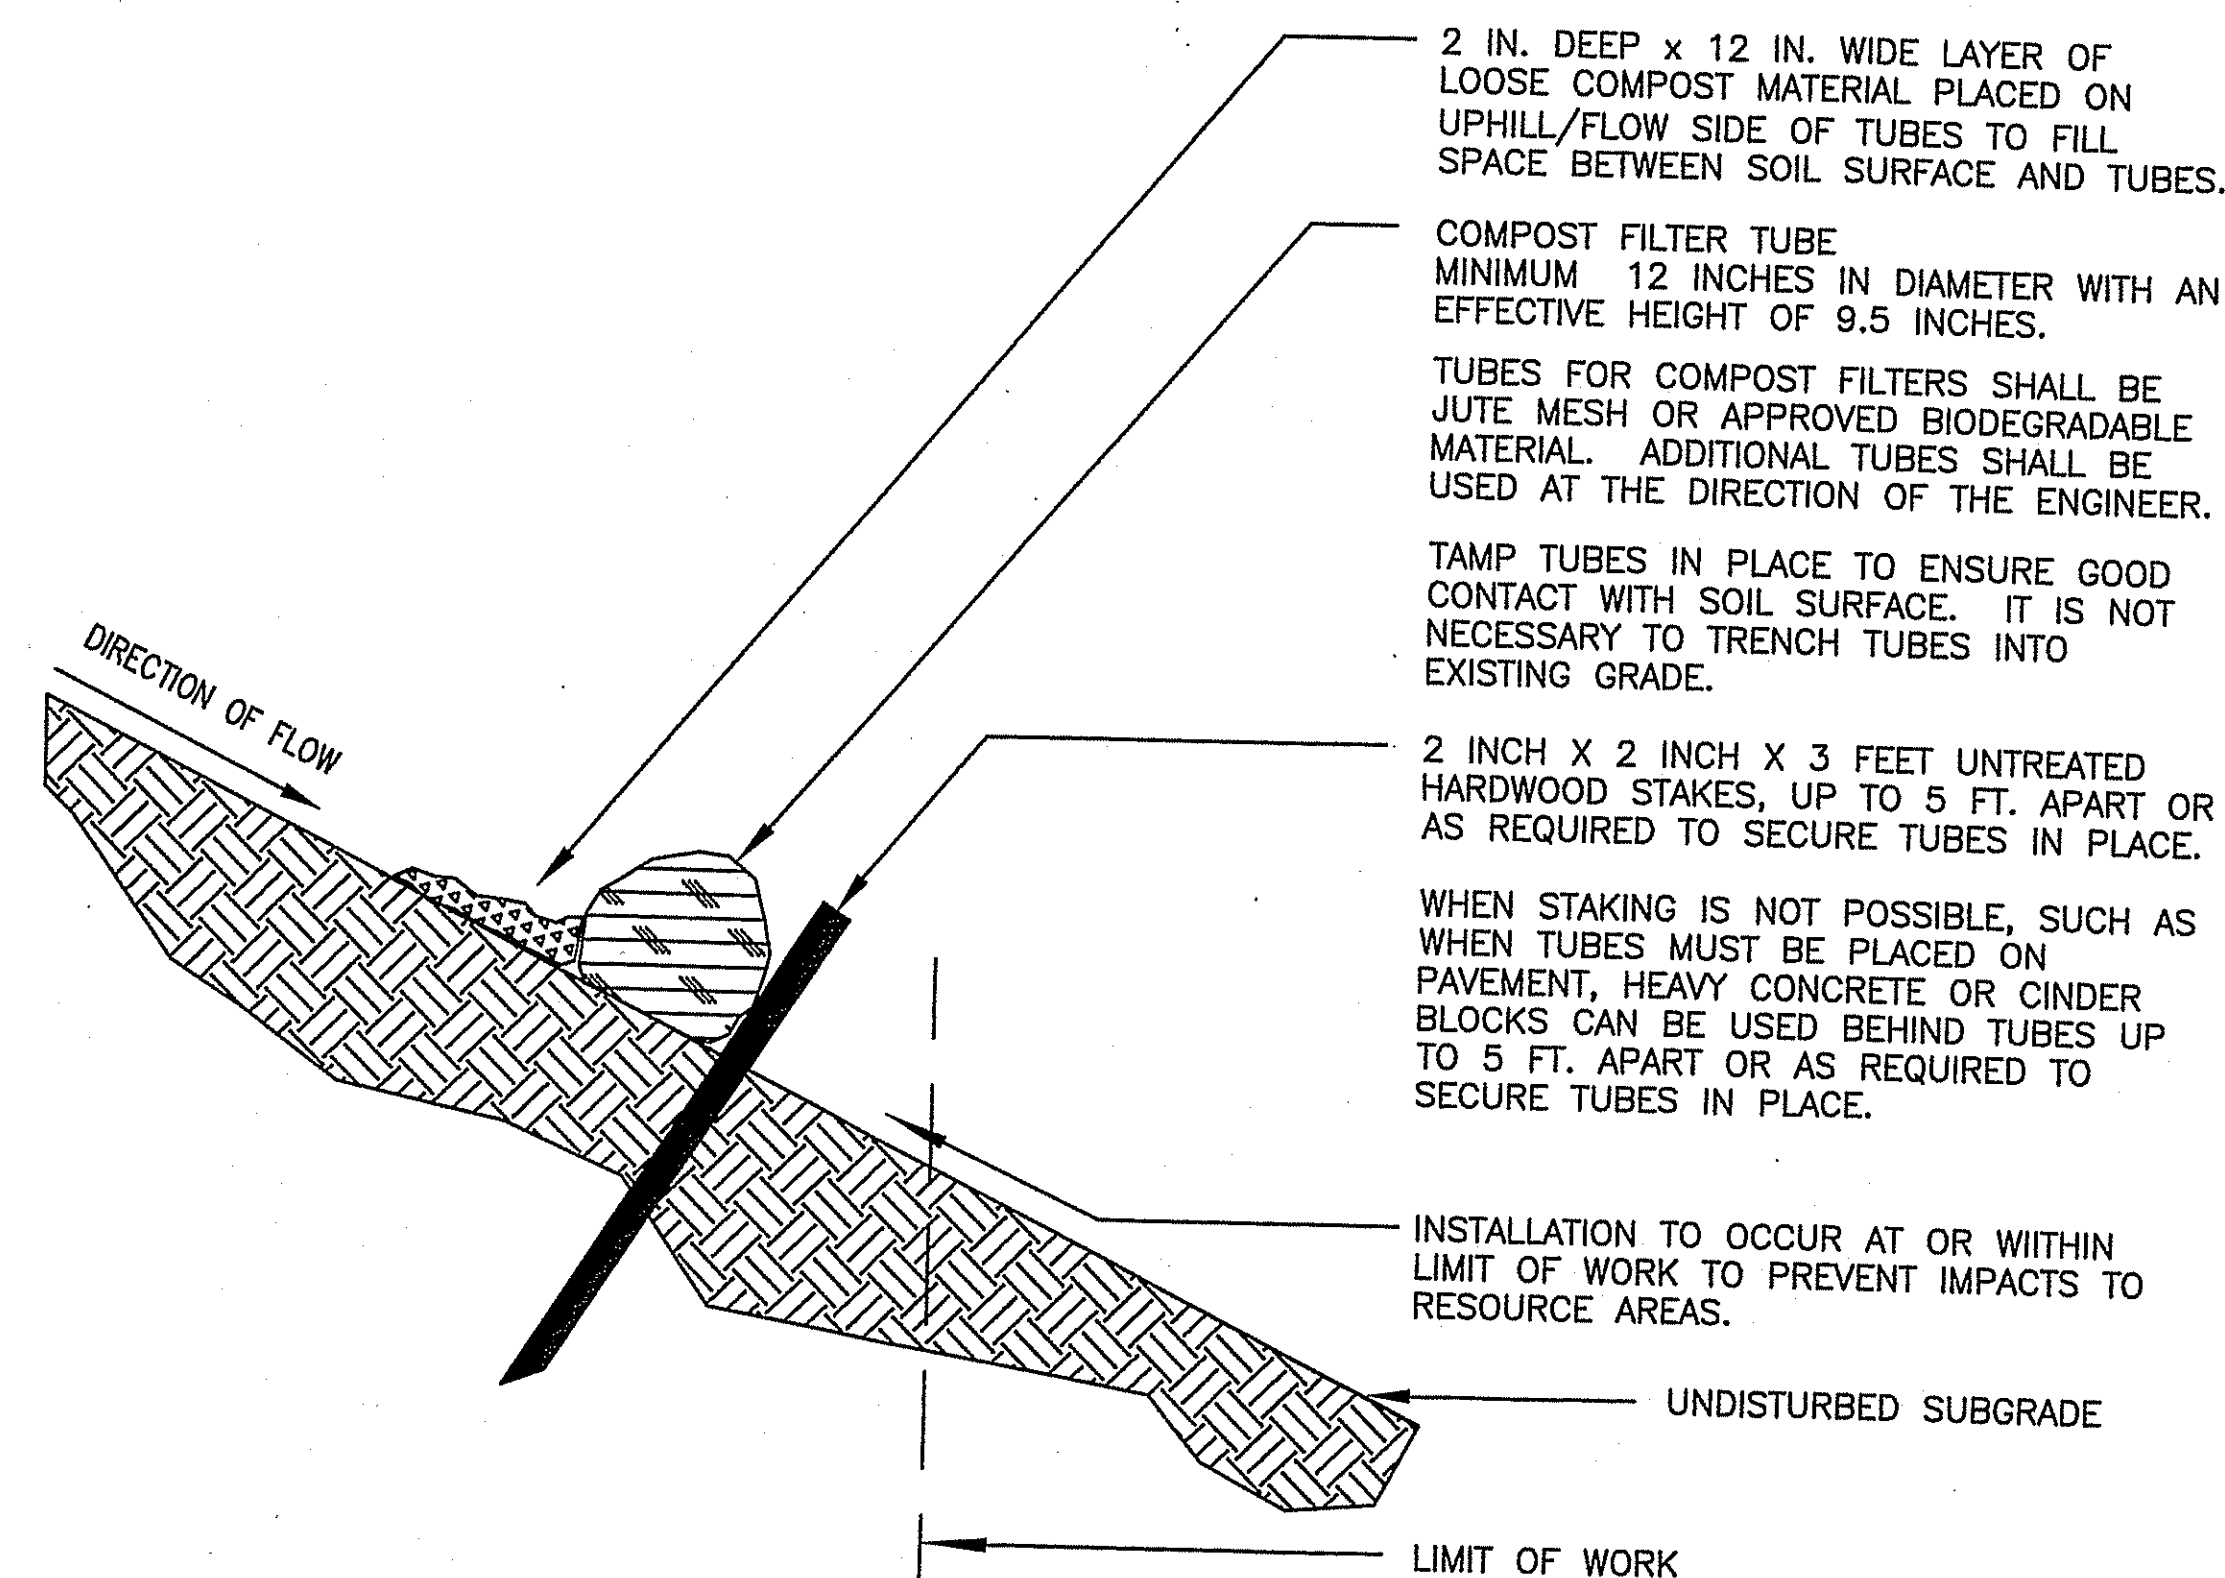


### LINEAR SEDIMENTATION AND EROSION CONTROL

SCALE: NOT TO SCALE  
DATE: SEPT 2011  
DWG: N/A

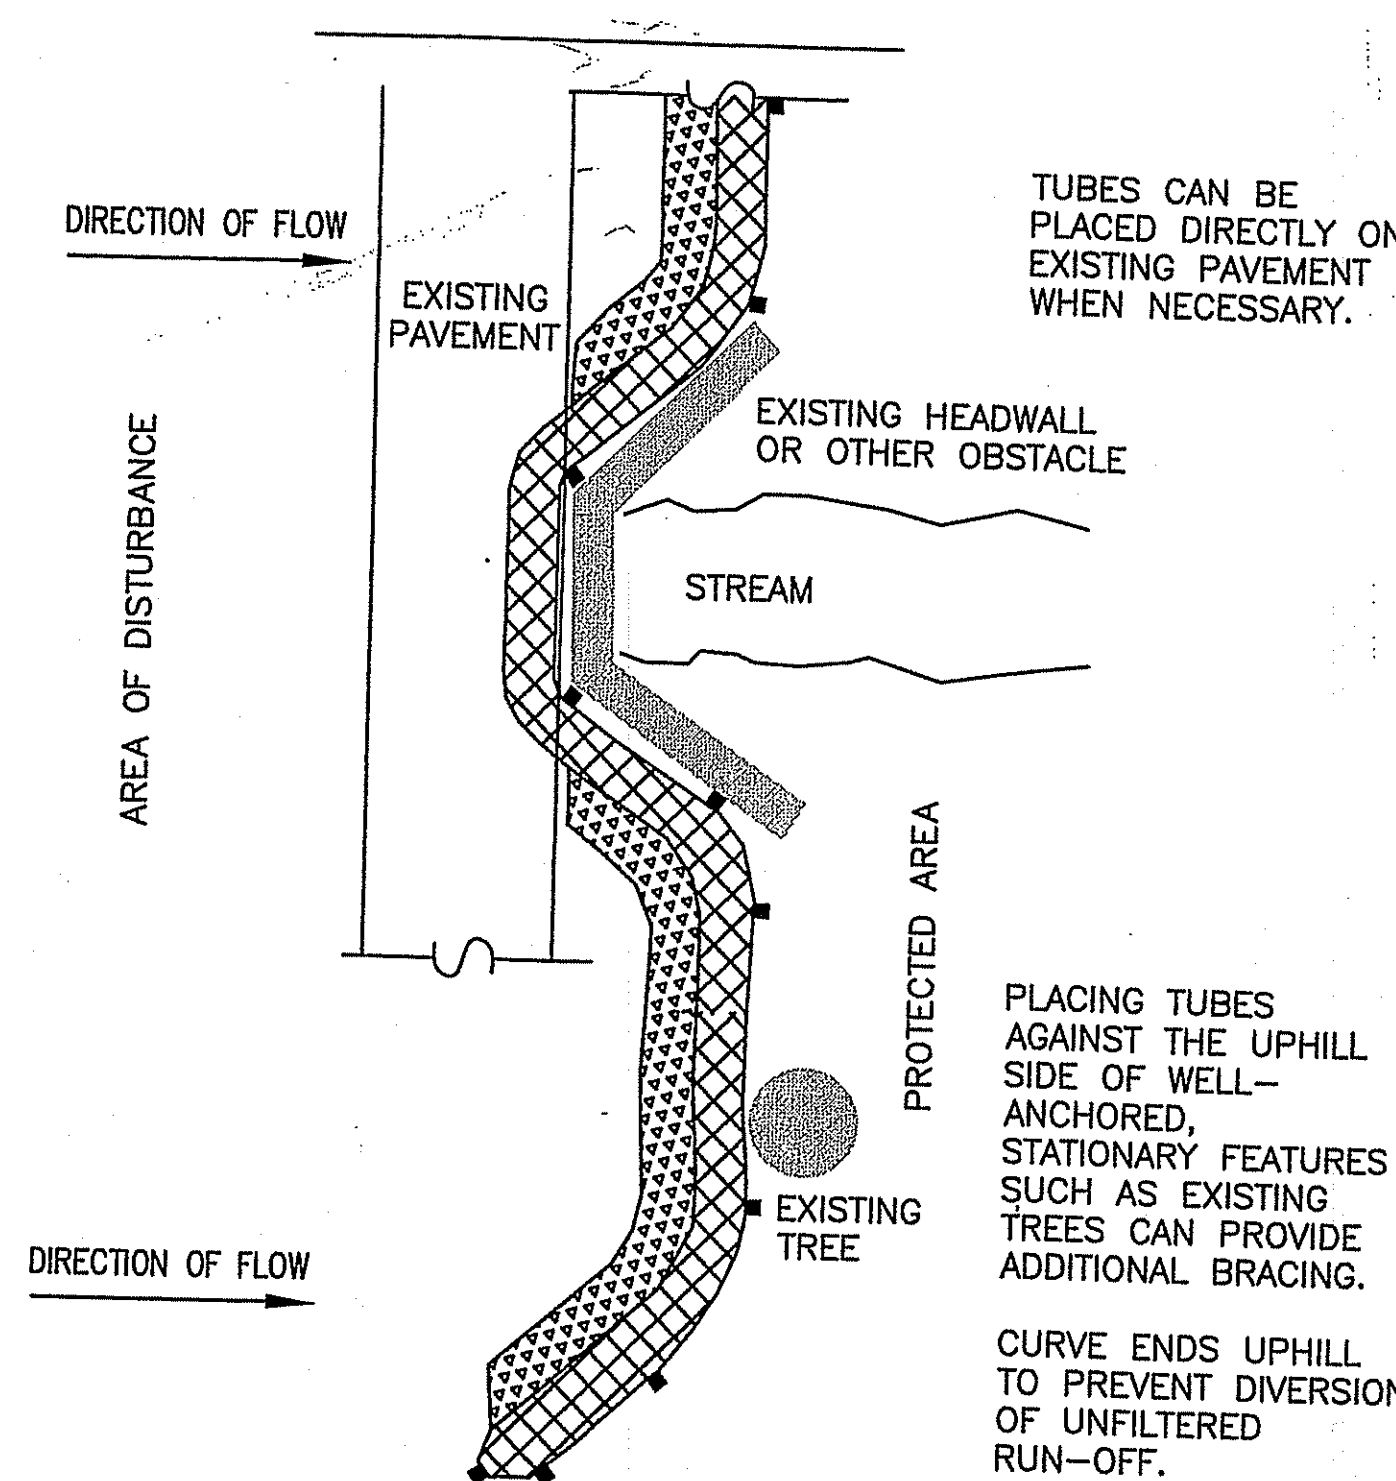

### PLAN VIEW

N.T.S.

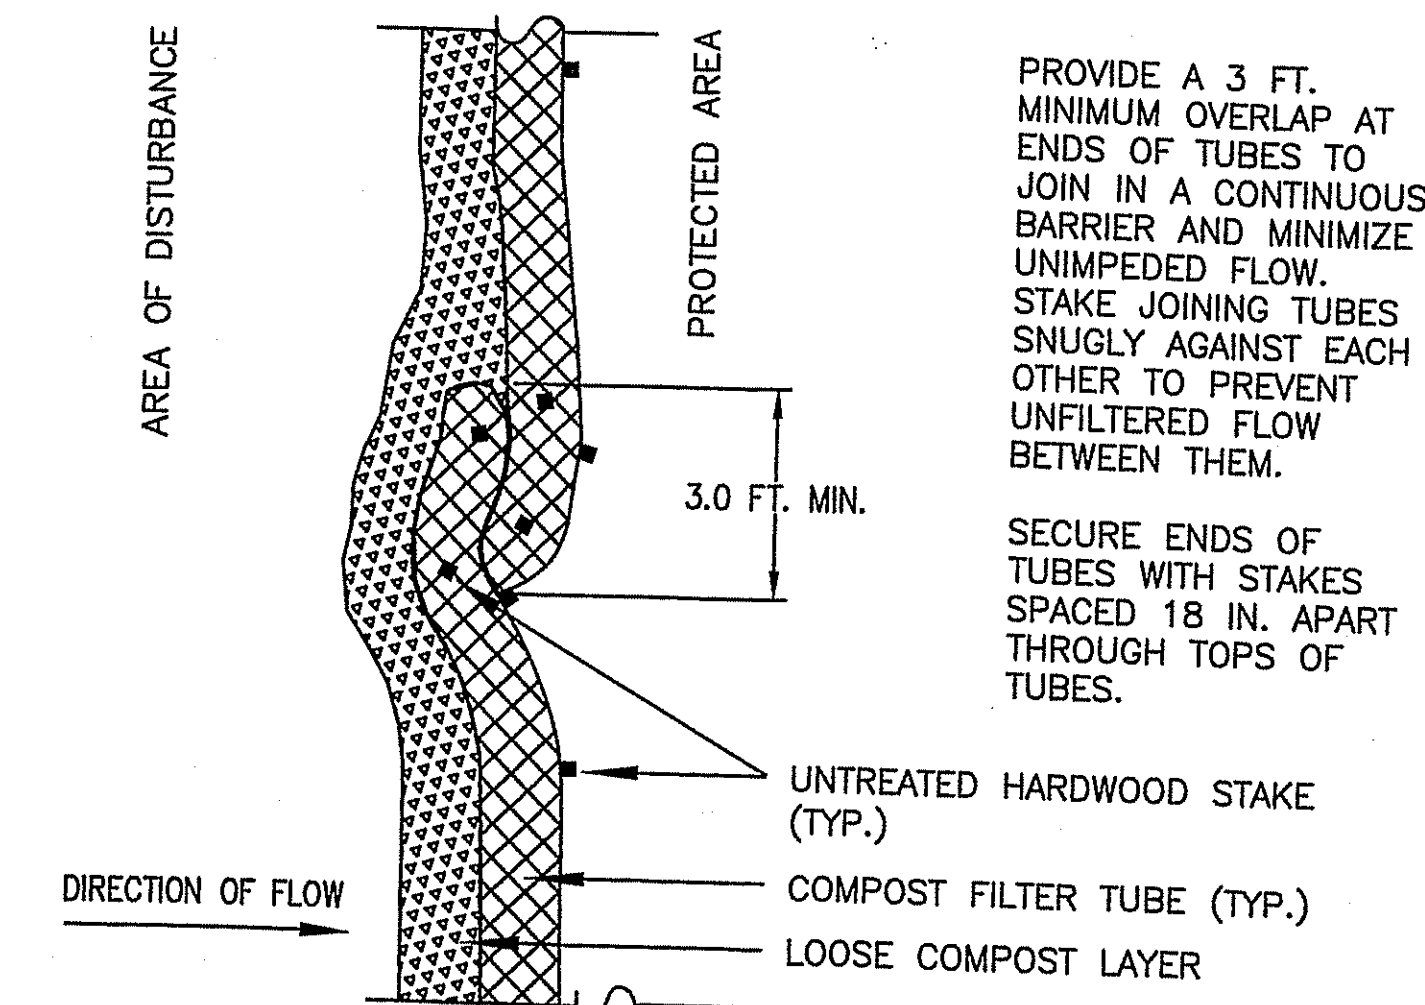

### PLAN VIEW - JOIN DETAIL

N.T.S.

#### NOTES:

1. PROVIDE A MINIMUM TUBE DIAMETER OF 12 INCHES FOR SLOPES UP TO 50 FEET IN LENGTH WITH A SLOPE RATIO OF 3H:1V OR STEEPER. LONGER SLOPES OF 3H:1V MAY REQUIRE LARGER TUBE DIAMETER OR ADDITIONAL COURSING OF FILTER TUBES TO CREATE A FILTER BERM. REFER TO MANUFACTURER'S RECOMMENDATIONS FOR SITUATIONS WITH LONGER OR STEEPER SLOPES.
2. INSTALL TUBES ALONG CONTOURS AND PERPENDICULAR TO SHEET OR CONCENTRATED FLOW.
3. DO NOT INSTALL IN PERENNIAL, EPHEMERAL OR INTERMITTENT STREAMS.
4. CONFIGURE TUBES AROUND EXISTING SITE FEATURES TO MINIMIZE SITE DISTURBANCE AND MAXIMIZE CAPTURE AREA OF STORMWATER RUN-OFF.

5105  
ARLINGTON - BELMONT (SPY POND)  
DRAINAGE REPAIRS AND IMPROVEMENTS  
SHEET NO. 14  
TOTAL SHEETS 14  
PROJECT FILE NO. 606280  
CONSTRUCTION DETAILS  
SHEET 5 - 10/10/11